

2024 City of Cleveland

Landmarks Commission

February 13, 2025

Julie Trott, Commission Chair Daniel Musson, Secretary







Certificates of Appropriateness

February 13, 2025





Case 24-014

Certificate of Appropriateness

Market Square Historic District

Previously Approved January 9th, 2025

Carriage Company 2168 West 25th Street

Renovations


Project Representatives: Joseph Del Re, MRN Ltd.

Ward 3: Councilmember McCormack





Carriage Co.

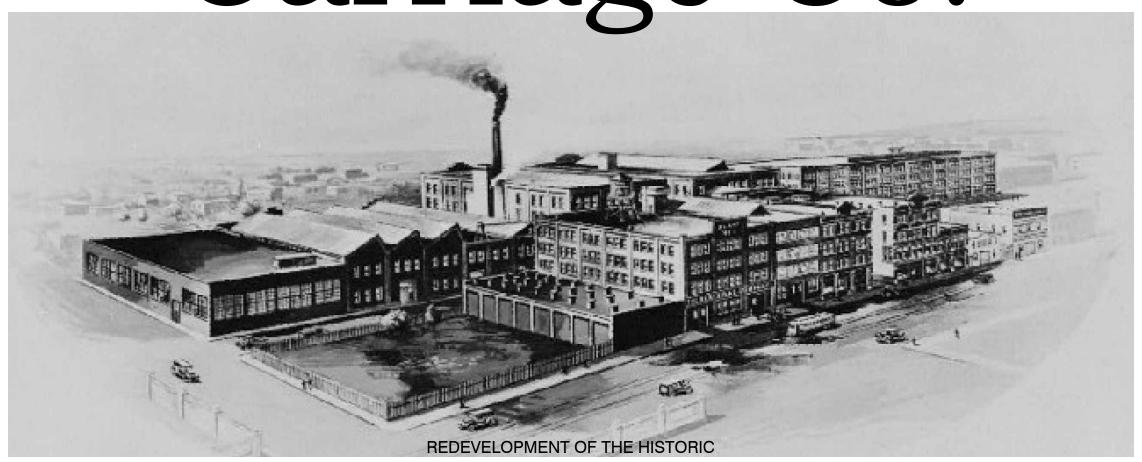

THE RAUCH & LANG CARRIAGE COMPANY BUILDING - 2168 W. 25th STREET - CLEVELAND, OHIO

GROSS BUILDING AREA SUMMARY:

	EXISTING (S.F.)	PROPOSED (S.F.)
FOURTH	41,012	41,311
THIRD	41,012	41,692
SECOND	69,463	68,044
FIRST	90,547	83,399
BASEMENT	7,666	7,666
TOTAL	249,700	239,089

2168 W. 25th Street Cleveland, Ohio



PREPARED FOR:



MRN LTD. 629 Euclid Avenue -Suite 1100 Cleveland, Ohio 44114

PREPARED BY:



Ohio City **COVER SHEET** December 19, 2024

G 0.1


























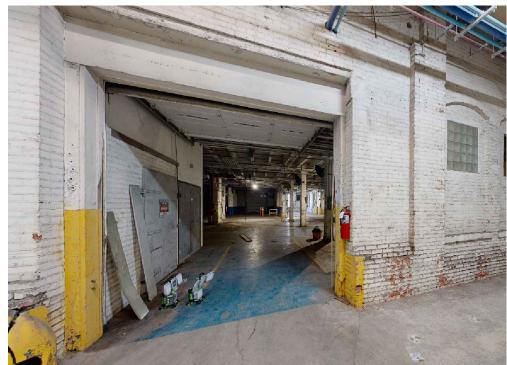


December 19, 2024








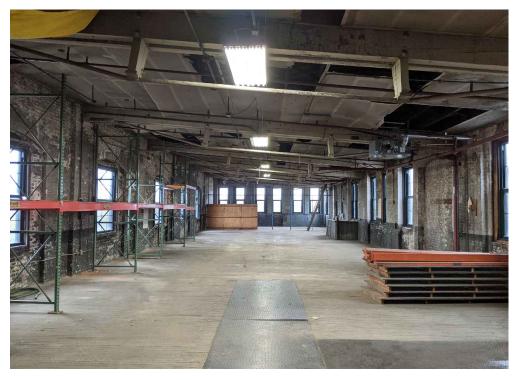



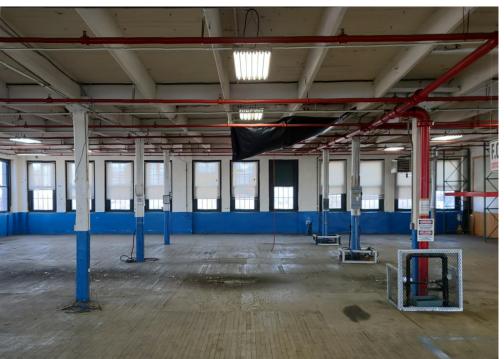


December 19, 2024









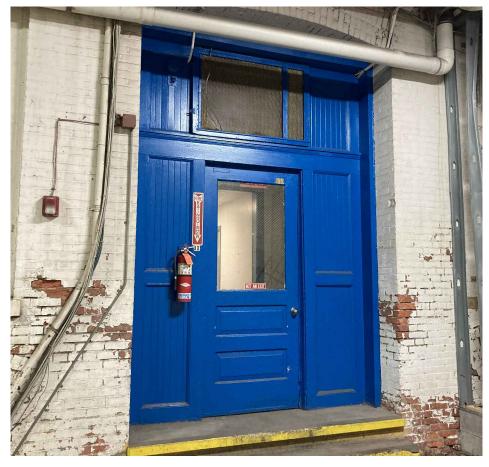







2168 W. 25th Street Cleveland, Ohio

EXPLANATORY DOCUMENT

EXTERIOR ELEVATIONS - EAST OVERALL February 28, 2023
REVISED: November 21, 2024

February 28, 2023
November 21, 2024

HPCA
Amendment No.1

A 5.0a






2168 W. 25th Street Cleveland, Ohio

EXPLANATORY DOCUMENT



A 5.0b




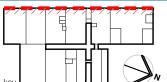








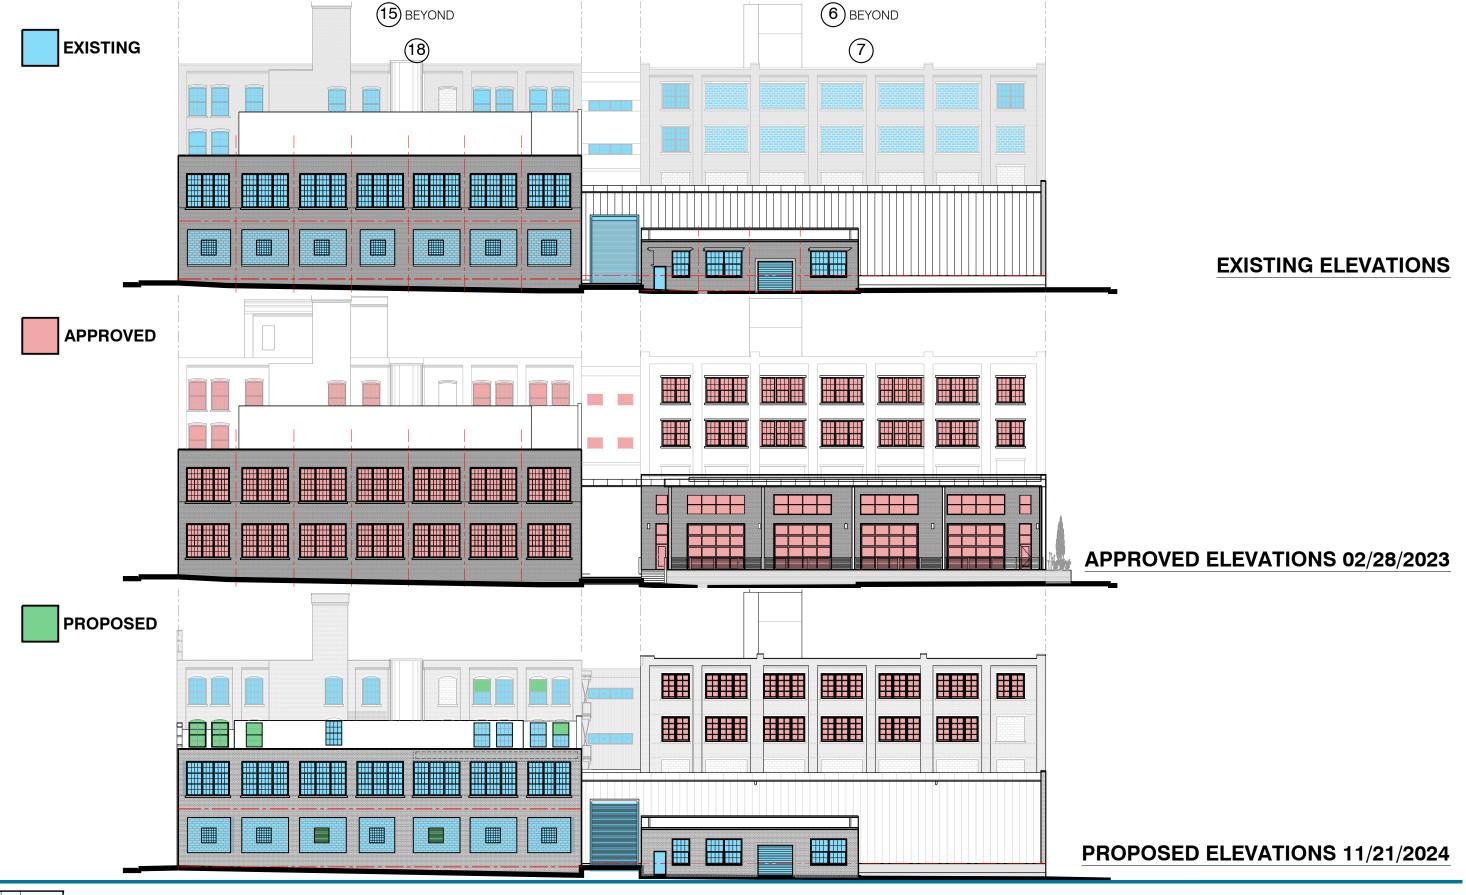

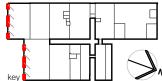









2168 W. 25th Street Cleveland, Ohio





2168 W. 25th Street Cleveland, Ohio

A 8.0b

#	OPERATION	WINDOW KEY NOTE		ZE	UNITS	ARCHED	QUANTITY	NOTES
1A	SINGLE HUNG	1	W 4'-10"	H 7'-0"	SINGLE	Y	3	UPPER SASH
1B	SINGLE HUNG	1	12'-1 1/2"	7'-9 1/2"	PAIR MULLED	N	2	UPPER RIGHT SASH
10	SINGLE HUNG	1	4'-10 1/2"	8'-11 1/4"	SINGLE	N	1	UPPER SASH
1D	SINGLE HUNG	1	12'-1 1/2"	8'-11 1/4"	PAIR	N	1	UPPER RIGHT SASH
1E	SINGLE HUNG	1	15'-3"	7'-9 1/2"	MULLED	N	1	UPPER RIGHT SASH
1F	SINGLE HUNG	1	4'-4"	7'-0"	MULLED SINGLE	Y	2	BOTH SASHES
1G	SINGLE HUNG	1	4'-4"	7'-0"	SINGLE	Y	2	LOWER SASH
1H	SINGLE HUNG	1	3'-10"	9'-2"	SINGLE	Y	1	UPPER SASH
11	SINGLE HUNG	1	4'-2"	7'-9 1/2"	SINGLE	N	1	UPPER SASH
1J	SINGLE HUNG	1	4'-0"	9'-2"	SINGLE	N	1	UPPER SASH
1K	SINGLE HUNG	1	4'-1"	9'-2"	SINGLE	N	1	UPPER SASH
								LOWER SASH
1L	SINGLE HUNG	1	4'-1"	9'-2"	SINGLE	N	1	
1M	SINGLE HUNG	1	4'-10"	8'-3"	SINGLE	Y	1	LIDDED SASH
1N	SINGLE HUNG	1	4'-10"	8'-3"	SINGLE	Y	3	UPPER SASH
10	SINGLE HUNG	1	4'-10"	8'-3"	SINGLE	Y	2	BOTH SASHES
2A	SINGLE HUNG	2	4'-10"	6'-7 3/4"	SINGLE	Y	1	3 SASH WINDOW (LOWEST
2B	SINGLE HUNG	2	4'-4"	8'-0"	SINGLE	Y	5	SASH IS OPERABLE) 3 SASH WINDOW (LOWEST
2C)	SINGLE HUNG	2	4'-4"	9'-2"	SINGLE	Y	6	SASH IS OPERABLE)
2D)	SINGLE HUNG	2	4'-4"	9'-2"	SINGLE	Y	2	
2E	SINGLE HUNG	2	3'-10"	9'-2"	SINGLE	Y	2	
2F	SINGLE HUNG	2	4'-10"	8'-3"	SINGLE	Y	27	
2G	SINGLE HUNG	2	4'-6"	8'-3"	SINGLE	Y	3	
2H	SINGLE HUNG	2	6'-5"	6'-9 1/4"	PAIR MULLED	N	1	
2l	SINGLE HUNG	2	6'-5"	7'-6 3/4"	PAIR MULLED	Y	2	
2J	SINGLE HUNG	2	6'-5"	7'-6 3/4"	PAIR MULLED	Y	1	NORTH PAIR OF SASHES ONLY
2K	SINGLE HUNG	2	6'-5"	9'-8"	PAIR MULLED	Y	1	
2L	SINGLE HUNG	2	3'-10"	6'-10 1/2"	SINGLE	N	12	
2M	SINGLE HUNG	2	7'-8"	6'-10 1/2"	PAIR MULLED	N	2	
2N	SINGLE HUNG	2	4'-6 1/4"	7'-6 3/4"	SINGLE	Y	1	
20	SINGLE HUNG	2	3'-4"	7'-6 3/4"	SINGLE	Y	4	
2P	SINGLE HUNG	2	6'-8"	7'-6 3/4"	PAIR MULLED	Y	2	
2Q	SINGLE HUNG	2	3'-8 1/4"	7'-6 3/4"	SINGLE	Y	2	
2R	SINGLE HUNG	2	9'-1 1/2"	12'-5 1/4"	PAIR	N	1	PAIR WITH EXISTING FRAMING
2S	SINGLE HUNG	2	7'-8"	5'-8"	SINGLE	N	2	
2T	SINGLE HUNG	2	7'-8"	11'-1 3/4"	SINGLE	N	3	
ЗА	SINGLE HUNG	3	4'-10"	7'-0"	SINGLE	Y	9	
3B	SINGLE HUNG	3	7'-7"	7'-0"	PAIR MULLED	N	3	
3C	SINGLE HUNG	3	11'-5"	7'-0"	TRIO MULLED	N	10	
3D	SINGLE HUNG	3	4'-10"	8'-4"	SINGLE	Y	8	
4A	FIXED	4	15'-5"	6'-0"	SINGLE	N	2	
4B	FIXED	4	3'-10"	6'-0"	SINGLE	N	1	
5A	DOUBLE HUNG	5	3'-6"	6'-7 3/4"	SINGLE	N	2	
5B	DOUBLE HUNG	5	3'-2"	7'-1 1/4"	SINGLE	N	5	
5C	DOUBLE HUNG	5	3'-2"	4'-8"	SINGLE	N	2	
5D	DOUBLE HUNG	5	3'-4"	4'-8"	SINGLE	N	1	
5E	DOUBLE	5	3'-8"	4'-8"	SINGLE	N	1	

	ADDITIONAL GLAZING UNIT LEGEND										
	#	OPERATION	TYPE	SI. W	ZE H	PLACEMENT	ARCHED	QUANTITY	NOTES		
	FW-A	FIXED	FIRE	3'-8 1/4"	7'-6 3/4"	INTERIOR	Υ	1			
	FW-B	FIXED	FIRE	3'-5"	7'-6 3/4"	INTERIOR	Υ	2			
_ ≥	FW-C	FIXED	FIRE	3'-5"	7'-1 1/2"	EXTERIOR	Υ	1			
02.20	FW-D	FIXED	FIRE	7'-8"	5'-8"	INTERIOR	N	1	VERTICAL MULLION REC		
JII. [12. 13.2024 U3.08.20	SW-A	FIXED	STORM	4'-6 1/4"	7'-1 1/2"	EXTERIOR	Υ	1			
2. 13.20	SW-B	FIXED	STORM	3'-8 1/4"	7'-1 1/2"	EXTERIOR	Υ	2			
<u>-</u>	SW-C	FIXED	STORM	6'-8"	7'-1 1/2"	EXTERIOR	Y	1			
Jolled	(SW-D)	FIXED	STORM	4'-4"	7'-1 1/2"	EXTERIOR	Υ	1			
_											

ADDITIONAL GLAZING TYPES

- FIRE WINDOWS REQUIRED AT BRIDGE AREA BETWEEN BUILDINGS C AND D AS SHOWN.
- FIRE WINDOWS TO BE FIRE PROTECTED AS REQUIRED BY OBC 3104.5.1.2 3/4 HOUR FIRE PROTECTION RATING. PROVIDE TECHNICAL GLASS PRODUCTS (TGP) FIREFRAMES DESIGNER SERIES WITH FIRELITE FIRE-RATED GLASS CERAMIC. FRAMES TO BE MOUNTED TO MASONRY OPENING PER MANUFACTURE'S STANDARD DETAILS AT EXTERIOR OF EXISTING
- EXISTING WINDOWS TO BE REPAIRED AS REQUIRED INCLUDING FRAME, SASH, AND GLAZING FOR REUSE IN FIXED, CLOSED POSITION. PAINT AND CLEAN PRIOR TO ADDITION OF FIRE WINDOWS TO EXTERIOR.
- FORM WINDOWS (SW)
- EXISTING WINDOWS TO BE REPAIRED AS REQUIRED INCLUDING FRAME, SASH, AND GLAZING FOR REUSE IN FIXED, CLOSED POSITION. PAINT AND CLEAN PRIOR TO ADDITION OF STORM WINDOWS TO EXTERIOR. STORM WINDOWS TO BE ALLIED WINDOW "INVISIBLE" STORM WINDOWS, ALLIED ONE LITE, (1) PANEL WITH CLEAR STANDARD CLIPS AND STANDARD 1/8" DSB GLAZING OR APPROVED EQUAL.
- FRAMING TO ALIGN WITH EXISTING WINDOW FRAMES. COLOR TO MATCH "HARTFORD GREEN." INSTALLATION PER MANUFACTURER'S STANDARD WRITTEN INSTRUCTIONS.

WINDOW KEY NOTE

NEW EXISTING FRAMES WITH REPLACEMENT SASH(ES) NEW WINDOW TO MATCH EXISTING REPLACEMENT WINDOWS NEW WINDOW TO MATCH HISTORIC TYPES NEW STOREFRONT

GENERAL NOTES

- CONTRACTOR TO VERIFY ALL OPENINGS AND CONDITIONS PRIOR TO ORDERING WINDOWS.
- EXISTING REPLACEMENT WINDOWS ARE: TRACO (NOW KAWNEER) TR-9100

NEW WINDOWS


SINGLE HUNG GL-1: 1" INSULATING GLASS CONSISTING OF 1/8" CLEAR TEMPERED 3/4" AIR SPACE

PRESET PANNING/INTERIOR TRIM

- 1/8" CLEAR TEMPERED AND COLONIAL MUNTINS (MILL FINISH) FINISH IS DURACRON HARTFORD GREEN UC#74266 WITH EXTERIOR SET HALF SCREEN ALUMINUM MESH, DARK AND STANDARD SILL SNAP LOCK ULTRA LIFT BALANCES HEAD AND JAMB RECEPTOR/SUBSILL OR
- WINDOWS WERE PROVIDED THROUGH G2 ARCHITECTURAL PRODUCTS LLC. FORT WAYNE, IN. NEW OPERABLE WINDOWS AND EXISTING WINDOWS WITH REPLACEMENT SASH(ES), WHERE THE CLEAR OPENING IS LESS THAN 36" ABOVE THE FINISHED FLOOR, AND WHERE THE VERTICAL DISTANCE FROM THE BOTTOM OF THE CLEAR OPENING TO FINISHED GRADE, ROOF, OR DECK BELOW IS GREATER THAN 72", TO BE PROVIDED WITH WINDOW OPENING
- OEBC 702.4. BASIS OF DESIGN: ANGEL VENTLOCK REVERSE RETROFIT OR APPROVED EQUAL. CONFIRM DEVICE IS COMPATIBLE FOR EACH WINDOW TYPE PRIOR TO ORDERING.

CONTROL DEVICES COMPLYING WITH ASTM F2090 PER OBC 1015.8 AND

WINDOW TYPE 1 NEW SASH(ES) TO RESTORE EXISTING

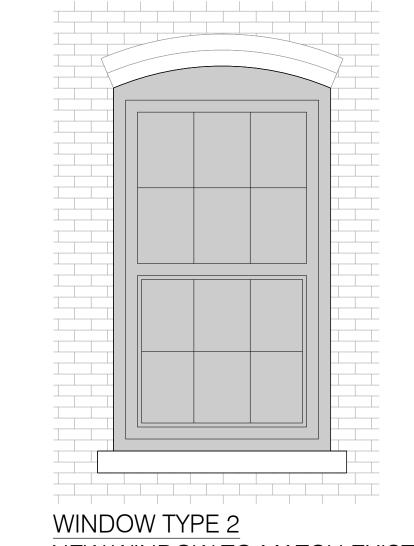

NEW WINDOW TO MATCH EXISTING


3A, 3B, 3C, 3D

WINDOW JAMB

4½"

3B, 3C

MULLION

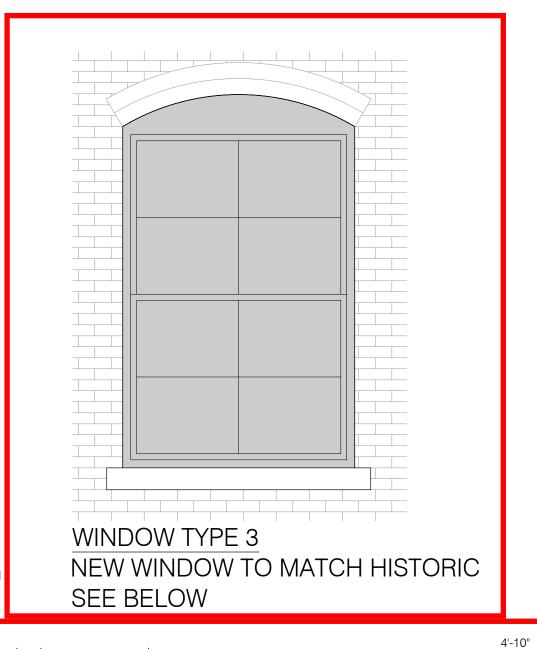

WINDOW TYPE 4


NEW STOREFRONT

3B

ROUGH OPENING

4'-61/2"

FRAME OPENING

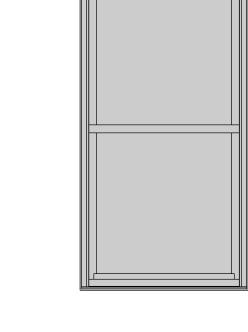

WINDOW TYPE 5 NEW WINDOW

7'-7"

ROUGH OPENING

3'-7½"

4'-10"

ROUGH OPENING


4'-61/2"

FRAME OPENING



CIVIL ENGINEER RIVERSTONE LANDSCAPE ARCHITECT: DERUlandscape architecture HISTORIC RESTORATION CONSULTANT: HP GROUP 1

ARCHITECT OF RECORD

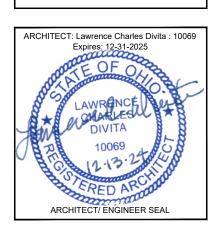

KEY MAP W 26[™]STREET W 25[™]STREET

A | ISSUED FOR PERMIT | 12-13-24 DRAWING TITLE:

REVISION HISTORY

NO. | PURPOSE OF ISSUE | DATE

WINDOWS JOB# | DRAWN BY: | REVIEWED BY: 22-975 | TS | LD

DRAWING NUMBER:

A8.50

WINDOW TYPES

- EXISTING FRAMES WITH REPLACEMENT SASH(ES)
- REMOVE EXISTING 1" MAPES-R INSULATED PANELS AND EITHER PROVIDE NEW GLAZING IN EXISTING SASH OR PROVIDE NEW SASH WITH GLASS MATCHING ADJACENT REPLACEMENT WINDOWS.
- NEW WINDOWS TO MATCH EXISTING REPLACEMENT WINDOWS
- IN LOCATIONS NOTED, REMOVE EXISTING CONSTRUCTION IN ORIGINAL
- MASONRY OPENINGS AND PROVIDE NEW WINDOWS TO MATCH EXISTING REPLACEMENT WINDOWS. ARRANGEMENT, FINISH, AND DETAILS TO MATCH ADJACENT EXISTING

NEW WINDOWS TO MATCH HISTORIC TYPES

REPLACEMENT WINDOWS.

- IN LOCATIONS DEEMED CRITICAL OR WHEN REPLACING EXISTING HISTORIC WINDOWS AS INDICATED. PROVIDE NEW ALUMINUM FRAMED WINDOWS CLOSELY MATCHING HISTORIC WINDOWS TO MEET NATIONAL PARK SERVICE STANDARDS PER HISTORIC PRESERVATION TAX INCENTIVES.
- AREAS OF CRITICAL MATCH ARE: 2.1. WINDOW UNIT PLACEMENT IN RELATION TO WALL PLANE
- 2.2. WINDOW FRAME SIZE AND SHAPE

AND BE LABELED FOR VERIFICATION. OPERABLE FENESTRATION:

U VALUE: 0.45

- 2.4. SASH ELEMENTS, WIDTH, AND DEPTH 2.5. MATERIALS AND FINISH
- 2.6. GLASS CHARACTERISTICS MEASUREMENTS AND PROFILES OF HISTORIC WINDOWS (OR A CONJECTURE THEREOF) ARE PROVIDED FOR REFERENCE.
- WINDOW SUPPLIER TO PROVIDE ACCURATE SHOP DRAWINGS IN CAD SHOWING CRITICAL DETAILS FOR SUBMISSION TO ARCHITECT AND NPS FOR FINAL SELECTION.
- PROVIDE ALUMINUM FRAMED WINDOWS BY KAWNEER (TRACO), WAUSAU, PEERLESS, WOJAN, GRAHAM, OR EQUAL MEETING PROJECT NEW WINDOW/GLAZING COMBINATION MEET ENERGY CODE REQUIREMENTS
 - .SHGC: 0.40 NEW WINDOWS TO BE A COMPLETE PACKAGE INCLUDING ALL ACCESSORIES, TRIMS, AND SEALANT.

NEW STOREFRONT

- NEW STOREFRONT TO BE KAWNEER 451-T CENTER GLAZED ALUMINUM
- FRAMING OR EQUAL. GLAZING TO BE 1" INSULATING GUARDIAN GLASS SN68, VIRACON VEI-2M OR EQUAL, 1" CLEAR (W/ LOW-E COATING, #2 SURFACE) ARGON FILLED CLEAR NEW STOREFRONT/GLAZING COMBINATION TO MEET ENERGY CODE REQUIREMENTS: **OPERABLE FENESTRATION:**
- U VALUE: 0.38 ENTRY SYSTEMS TO BE KAWNEER 250T INSULPOUR THERMAL ENTRANCES WITH MATCHING 1" INSULATING GLAZING.
- ENTRY FRAMING/GLAZING COMBINATION TO MEET ENERGY CODE REQUIREMENTS: ENTERANCE DOORS: U VALUE: 0.77

.SHGC: 0.40


NEW WINDOWS


- PROVIDE NEW ALUMINUM FRAMED SINGLE-HUNG THERMAL WINDOWS WITHOUT MUNTINS.
- WINDOWS TO BE KAWNEER AA 5450 DOUBLE HUNG FOR 1" DOUBLE GLAZING OR EQUAL. GLAZING TO BE 1" INSULATING. GUARDIAN GLASS SN68, VIRACON VEI-2M OR
- 1/2" SPACE (ARGON FILLED) WINDOW/GLAZING COMBINATION TO MEET ENERGY CODE REQUIREMENTS AND BE LABELED FOR VERIFICATION. OPERABLE FENESTRATION
- U VALUE: 0.45 NEW WINDOWS TO BE A COMPLETE PACKAGE INCLUDING ALL ACCESSORIES, SCREENS, TRIMS, AND SEALANT.

1" CLEAR (LOW E ON SURFACE #2)


SKYLIGHT NOTES

- OVERFRAMING FOR EXISTING SKYLIGHTS
- EXISTING SAWTOOTH SKYLIGHTS TO BE REPAIRED/REPLICATED TO MATCH EXISTING. GLASS IS TO BE STRIPPED OF PAINT AND GLAZING COMPOUND IS TO BE REPAIRED. PAINT FRAME/SASH PRIOR TO INSTALLATION OF NEW
- NEW EXTERIOR SKYLIGHT OVER EXISTING TO BE VELUX NORTHLIGHT 25-90 DEGREES. VERTICAL MULLIONS TO ALIGN WITH CENTERLINES OF EXISTING
- WINDOW SEGMENTS AND EXTEND AT LEAST AS HIGH VERTICALLY. GLAZING TO BE MANUFACTURER'S STANDARD CLEAR INSULATING UNITS AND SHALL COMPLY WITH OBC 2504 FOR SAFETY GLAZING.
- PROVIDE MANUFACTURER'S STANDARD FLASHING AND ACCESSORIES FOR SUPPLIER TO PROVIDE FULL SHOP DRAWINGS AND FIELD MEASUREMENTS SHOWING NEW ASSEMBLY IN RELATION TO EXISTING SAWTOOTH SKYLIGHT AND DEFINE ALL LOADS AND ATTACHMENT REQUIREMENTS FOR STRUCTURAL PROVISION/COORDINATION.

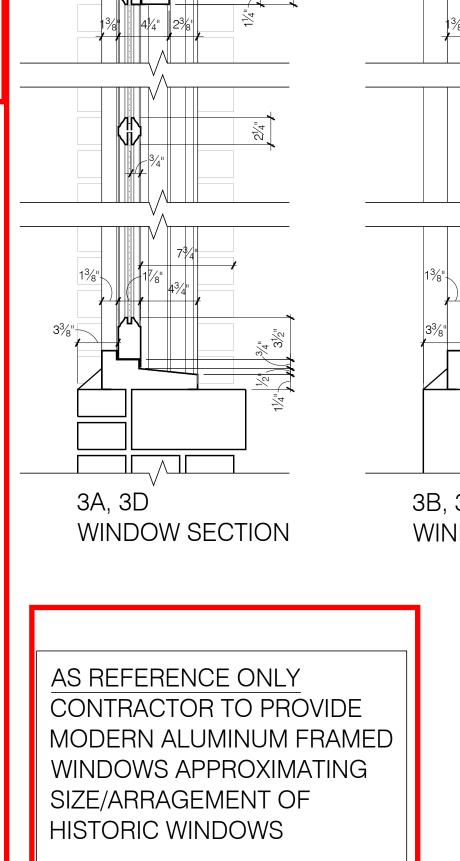

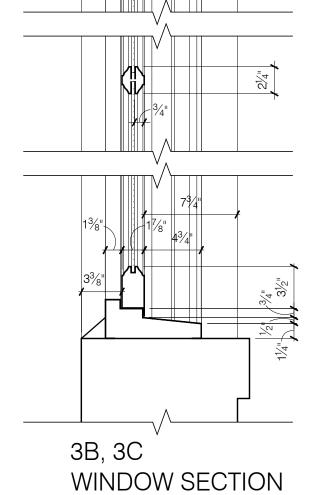

11'-5" **ROUGH OPENING** 3'-7½" 3'-7½"

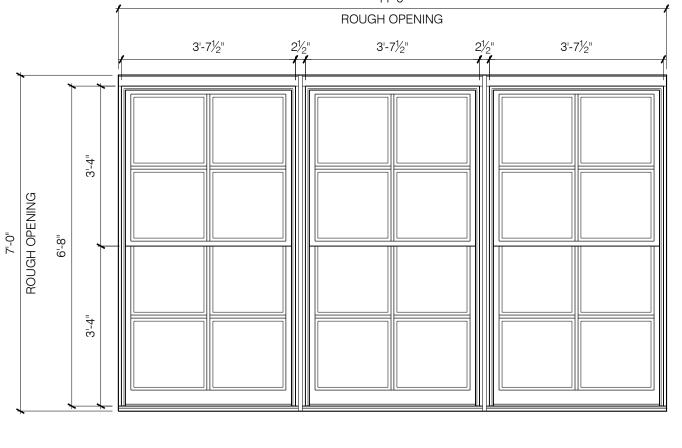

3A

3C



EQ.


15'-5" EQ.


EQ.

4B

3'-10"

3'-6"

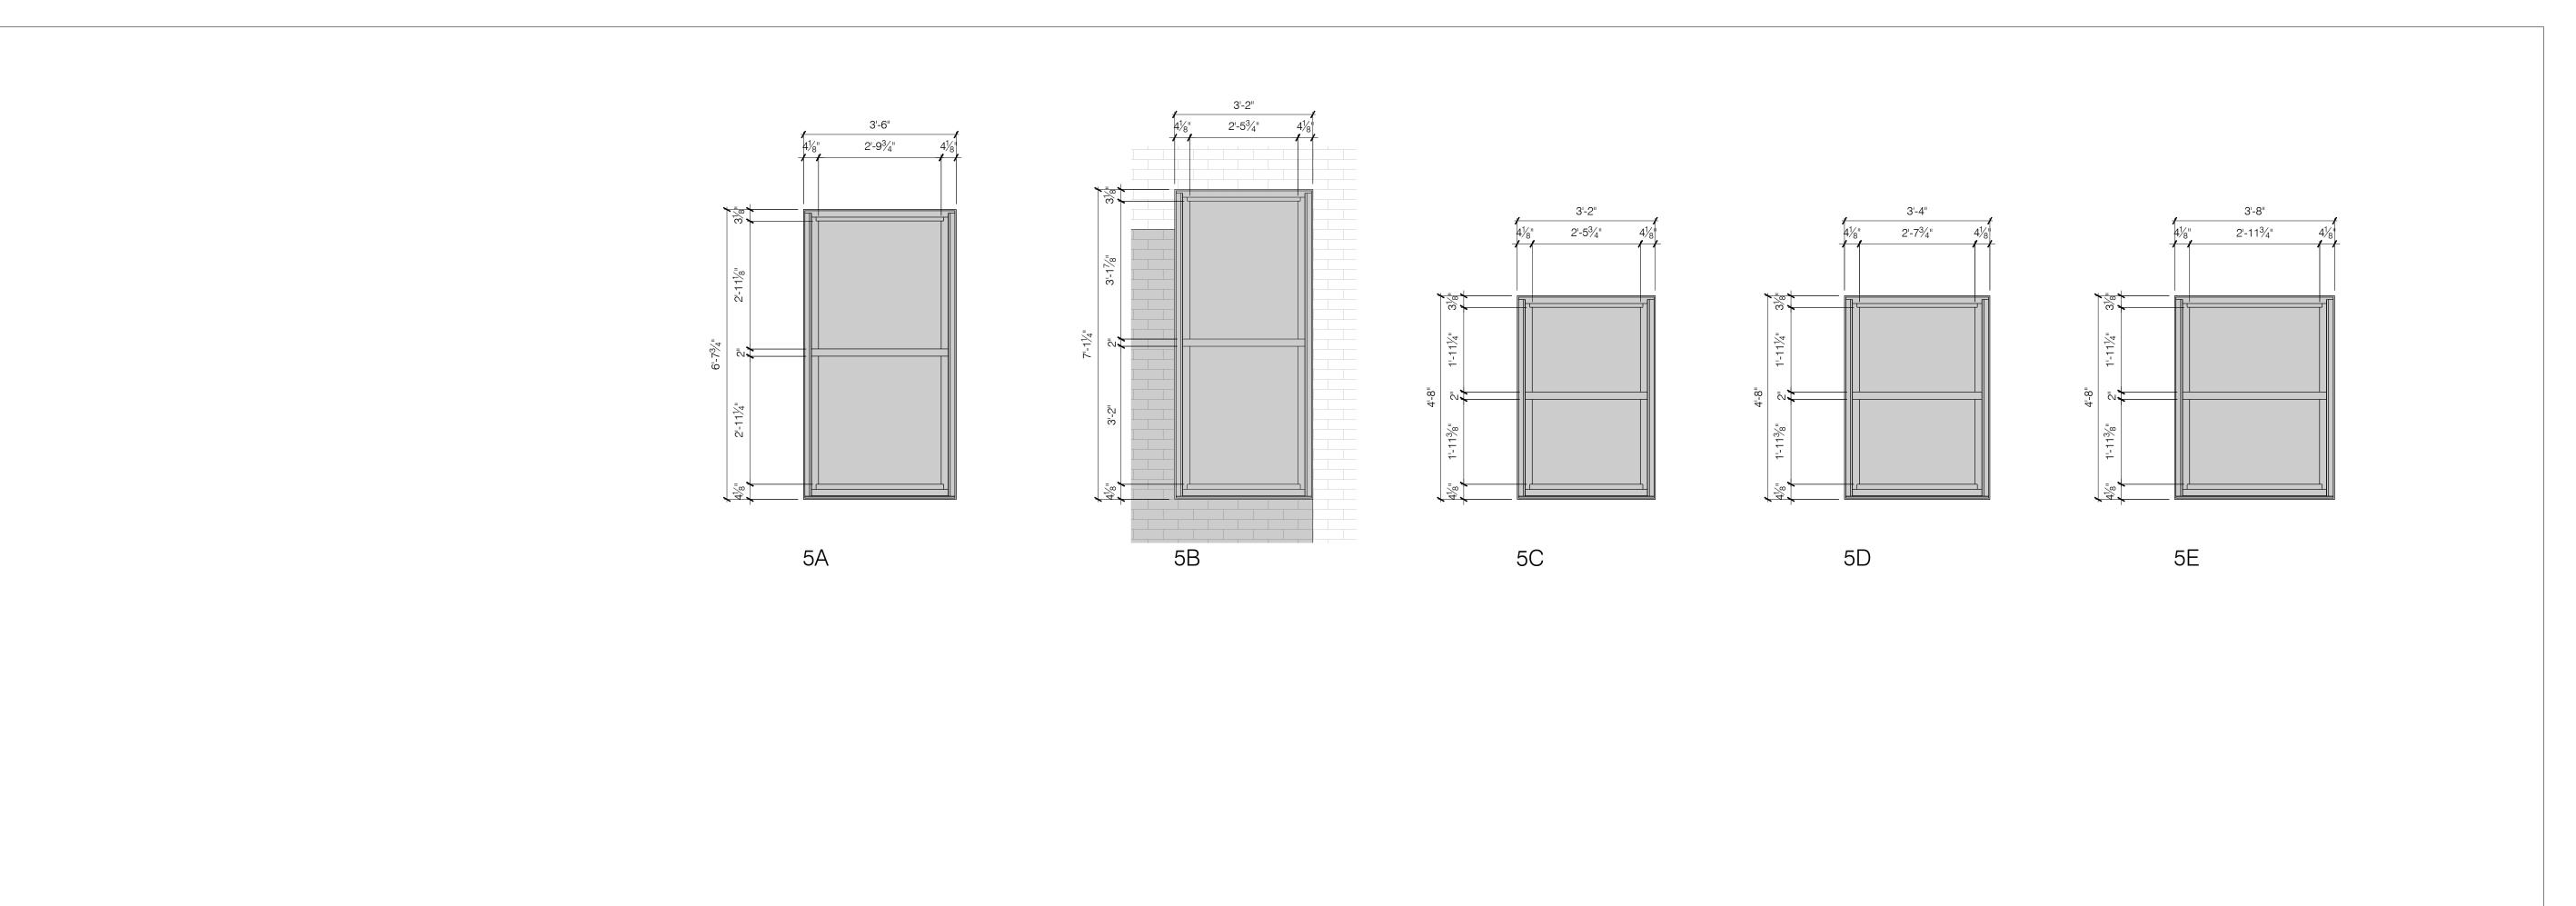

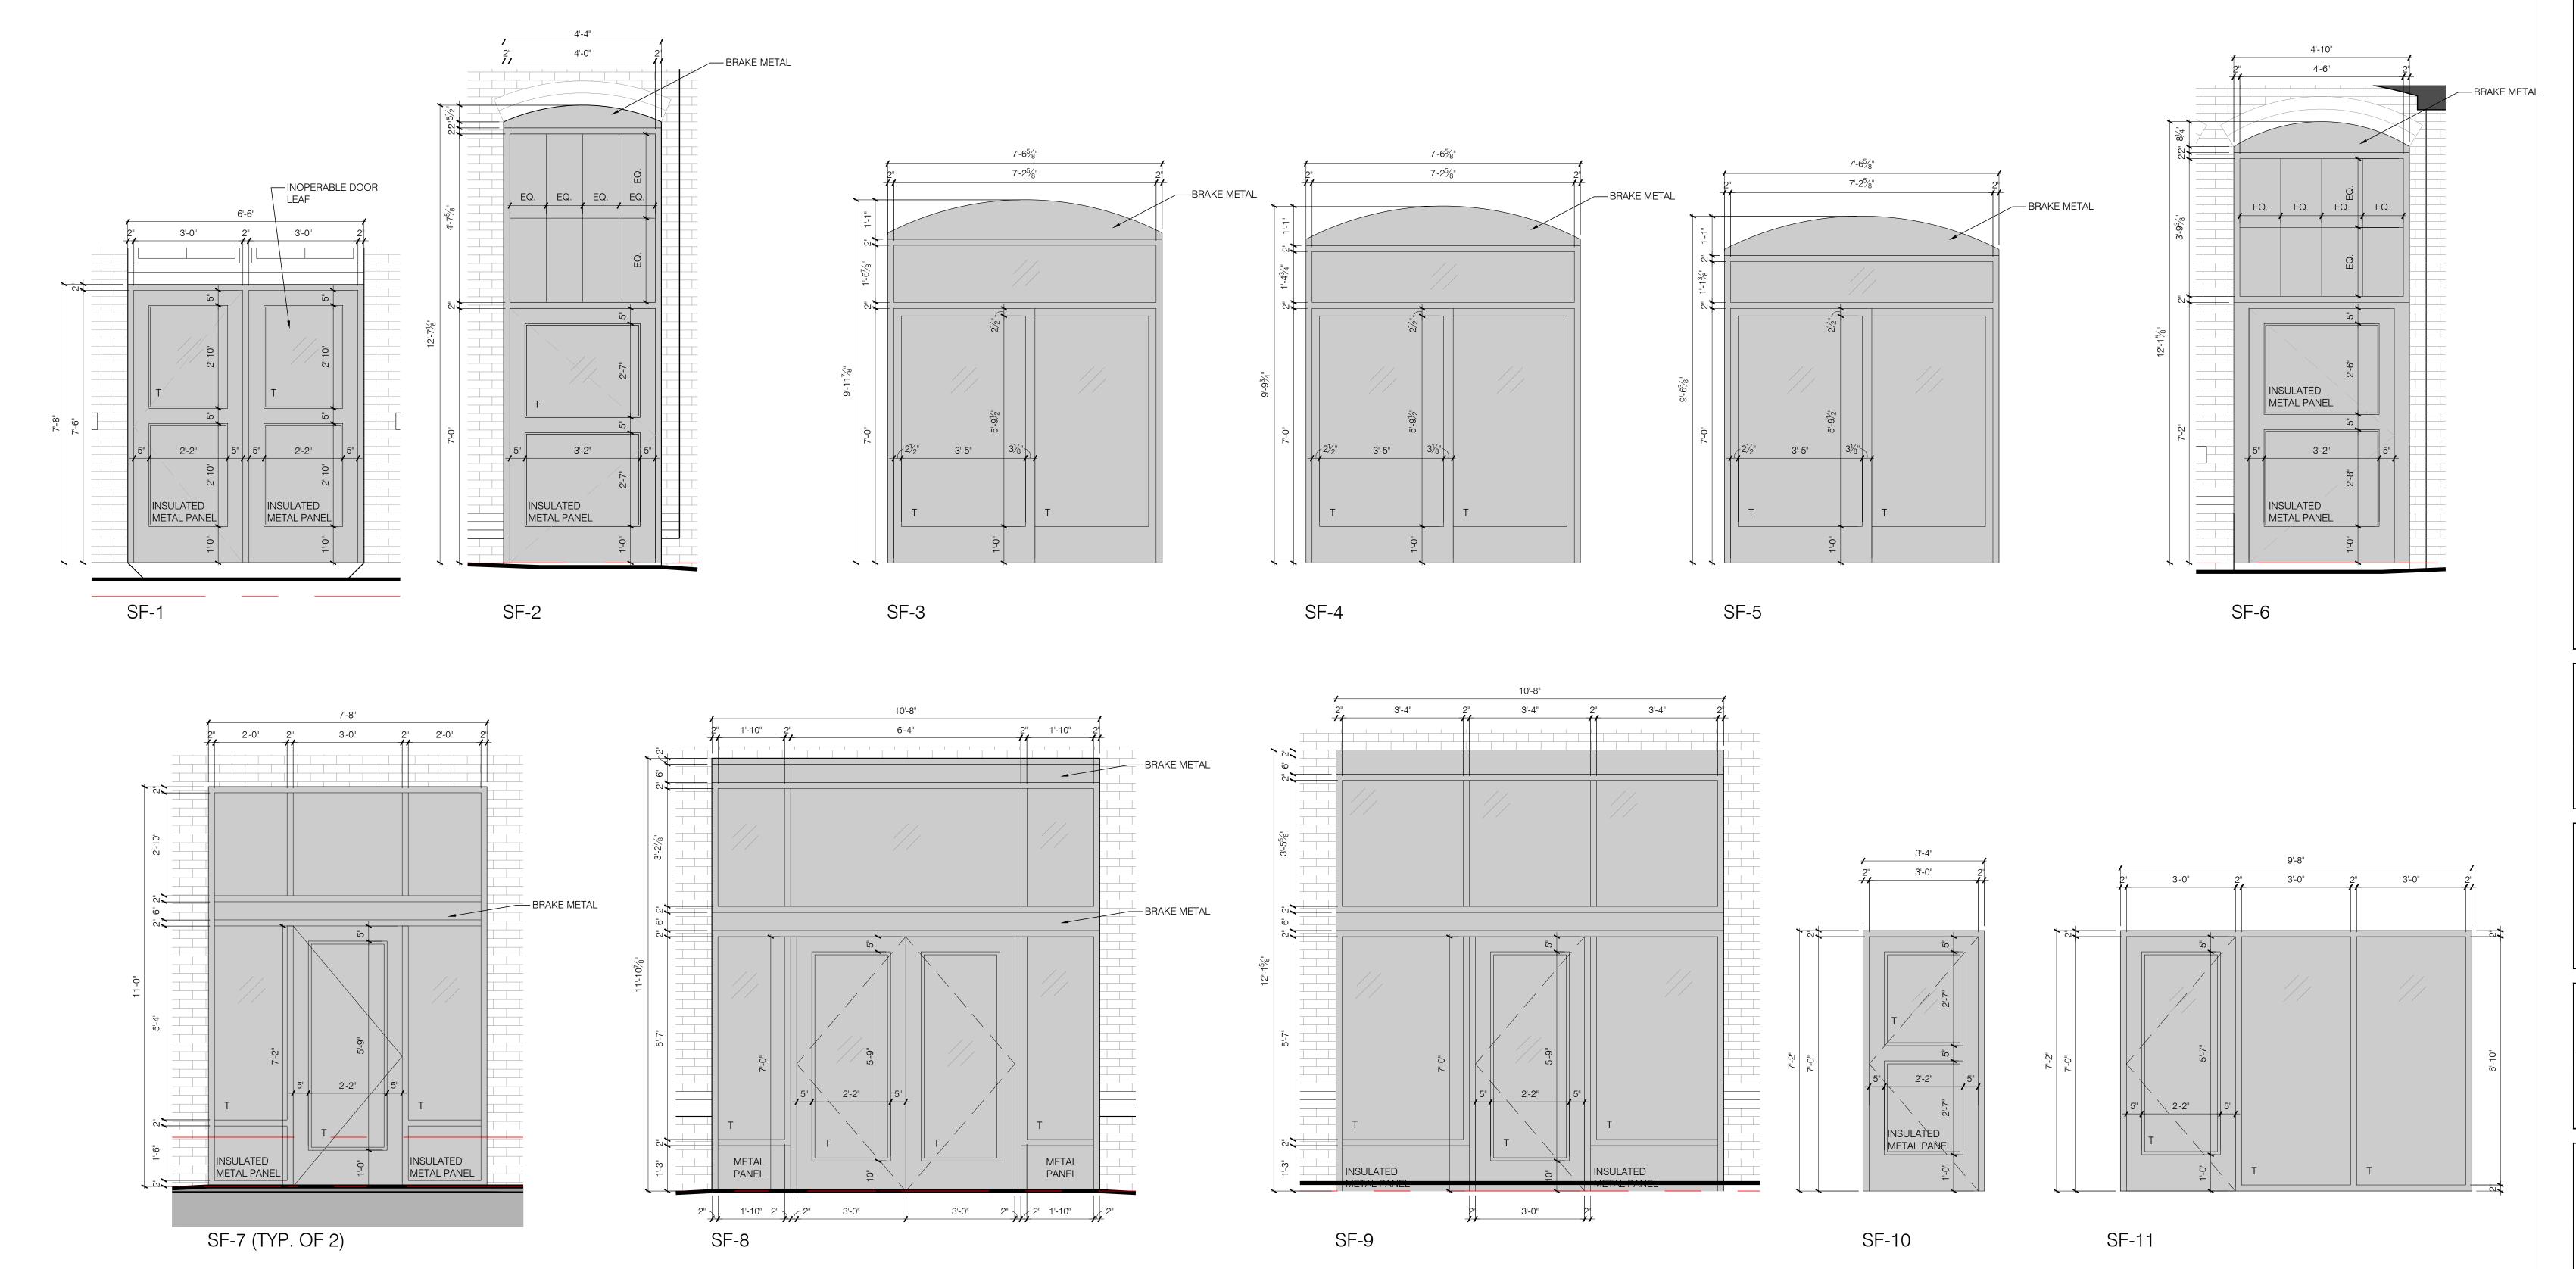








CIVIL ENGINEER RIVERSTONE

LAND SURVEYING - ENGINEERING - DESIGN
3800 LAKESIOE AVENUE - SUITE 100

WWW.RIVERSTONESURVEY.COM LANDSCAPE ARCHITECT: DERUlandscape architecture HISTORIC RESTORATION CONSULTANT: HP GROUP LI



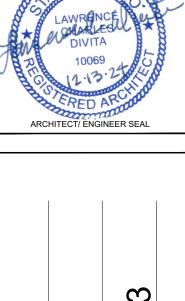

THE CARRIAGE COMPANY

HISTORIC RENOVATION

PROJECT NAME

2168 W. 25th ST | Cleveland, Ohio 44113

W 25[™]STREET

REVISION HISTORY: A | ISSUED FOR PERMIT |12-13-24

DRAWING TITLE: WINDOWS & STOREFRONTS

JOB# | DRAWN BY: | REVIEWED BY: 22-975 | TS | LD


DRAWING NUMBER: A8.51

Α

Window Type 2 (Traco to match existing)



Window Type 2 (Traco to match existing)

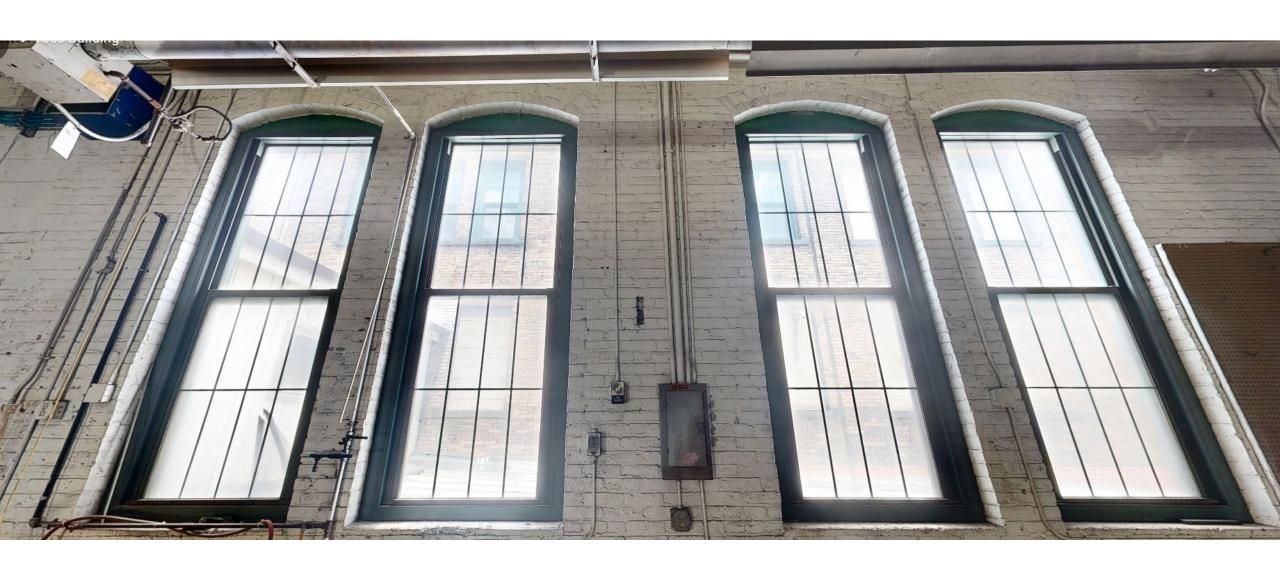

DATE: 8/9/10 PAGE: 1 OF 14

PROJECT NAME: VOSS BUILDING

SHIP TO ADDRESS: 2168 WEST 25TH STREET

CLEVELAND, DH 44113

CUSTOMER: C & K SERVICES

GLASS SCHEDULE									
GLASS TYPE	GLASS TYPE INFILL SINGLE OR DESCRIPTION THICKNESS INSULATING EXTERIOR LITE AIR SPACE INTERIOR LITE								
GE1100 111 E	1HTCKNF22	INSULATING	EXTERIOR LITE	AIR SPACE	INTERIOR LITE				
■ GL-1	1"	INS.	1/8" CLEAR TEMP	1/8" CLEAR TEMP 3/4" AIR 1/8" CL					
■ GL-2	■ GL-2 1' MAPES INT. & EXT. SMOOTH ALUMINUM SKINS								
	PANEL INT. & EXT. HARTFORD GREEN PAINTED FINISH								
NDTE: GL	NDTE: GL-1 IS TO HAVE COLONIAL MUNTINS.								

<u>SCREENS</u>								
SCREEN MESH	SCREEN MESH							
■ ALUMINUM MESH ■ DARK □ BRIGHT	■ HALF SCREEN							
☐ FIBERGLASS MESH (DARK)	☐ FULL SCREEN							
STAINLESS STEEL MESH (, 009)	■ EXTERIOR SET							
☐ SECURITY / PROTECTION SCREEN	☐ INTERIOR SET							

<u>HARDWARE</u>
■ STANDARD SILL SNAP L□CK
■ ULTRA LIFT BALANCES

WINDOW FINISH								
ANODIZED	PAINTED							
☐ CLASS II CLEAR	■ DURACR□N							
☐ CLASS I CLEAR	☐ ACRYNAR							
☐ CHAMPAGNE	☐ DURANAR							
□ LIGHT BRONZE	☐ DURANAR XL							
☐ MEDIUM BRONZE	FINISH NAME:							
☐ DARK BR□NZE	HARTFORD GREEN							
☐ BLACK	UC# 74266							


PROJECT INFORMATION

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PAGE	: 2	OF	14
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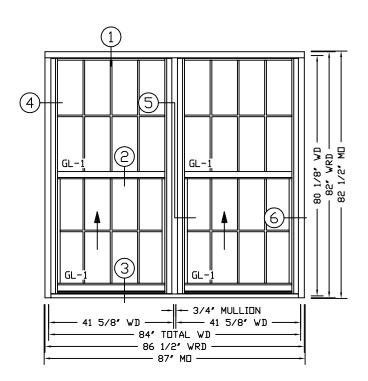
GENE	ERAL NOTES

<u>ACCESSORIES</u>									
ACCESSORIES	BY TRACO	BY ERECTOR	NOT BY TRACO	SHIP IN STOCK LENGTHS	PLANT CUT TO SIZE	FURNISHED OVERSIZE	PLANT PRE- DRILL	FIELD DRILL	COMMENTS
FASTENERS TO WINDOWS									
FASTENERS TO BUILDING									
ANCHOR CLIPS									N/A
STEEL ANCHORS									N/A
STEEL REINFORCING									N/A
INTERIOR STOOL									N/A
EXTERIOR SILL									N/A
SUBSILL									
RECEPTOR	\								
MULLIONS	/								
BRAKE FORM									N/A
SEALANT		\							
EXTERIOR PANNING	\								
INTERIOR TRIM	\								
MULLION COVERS									N/A
INSULATION			>						
BLOCKING			>						

DATE: 8/9/10 PAGE: 3 OF 14

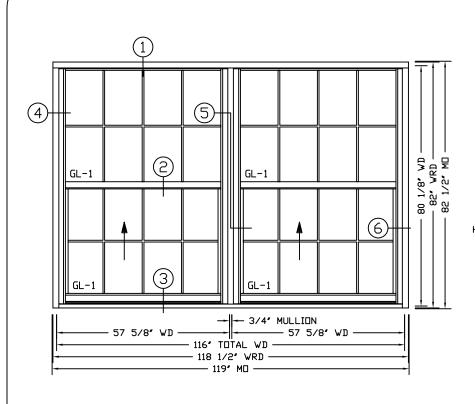


UNIT MARK A (3) REQD TR-9100 SINGLE HUNG
GLASS TYPE: GL-1
3 PCS MULLION (S-035)
HEAD & JAMB RECEPTOR (S-072 W/S-071) SUBSILL (S-1595)




UNIT MARK B (2) REQD TR-9100 SINGLE HUNG
GLASS TYPE: GL-1
3 PCS MULLIUN (S-035)
HEAD & JAMB RECEPTUR (S-072 W/S-071)
SUBSILL (S-1595)

WD = WINDOW DIMENSION
DLO = DAY LIGHT OPENING DIMENSION
WRD = WINDOW WITH RECEPTOR DIMENSION
MO = MASONRY OPENING DIMENSION

DATE: 8/9/10 PAGE: 4 OF 14

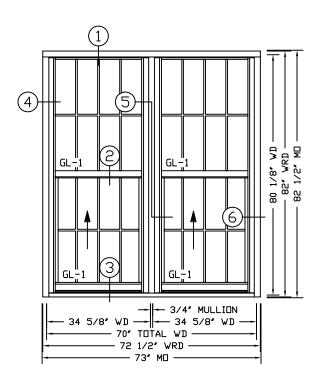


UNIT MARK (1) REQD TR-9100 SINGLE HUNG
GLASS TYPE: GL-1
3 PCS MULLION (S-035)
HEAD & JAMB RECEPTOR (S-072 W/S-071)
SUBSILL (S-1595)

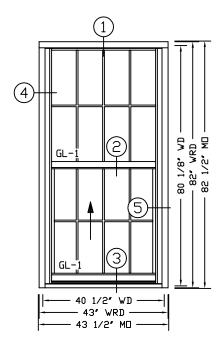


UNIT MARK (D) (2) REQD TR-9100 SINGLE HUNG
GLASS TYPE: GL-1
HEAD & JAMB RECEPTOR (S-072 W/S-071) SUBSILL (S-1595)


WD = WINDOW DIMENSION
DLO = DAY LIGHT OPENING DIMENSION
WRD = WINDOW WITH RECEPTOR DIMENSION
MO = MASONRY OPENING DIMENSION

DATE: 8/9/10 PAGE: 5 OF 14

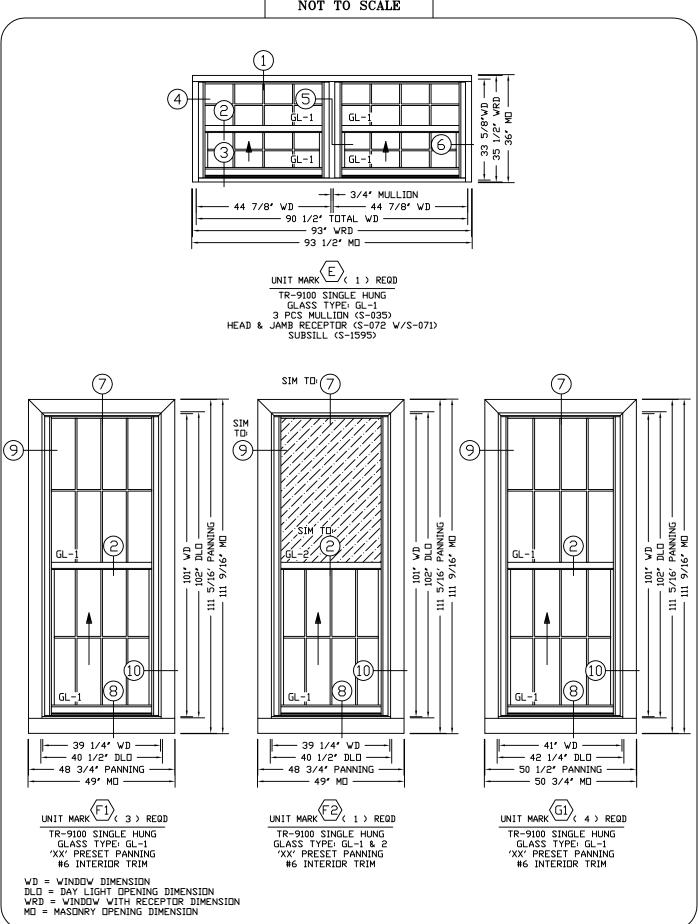

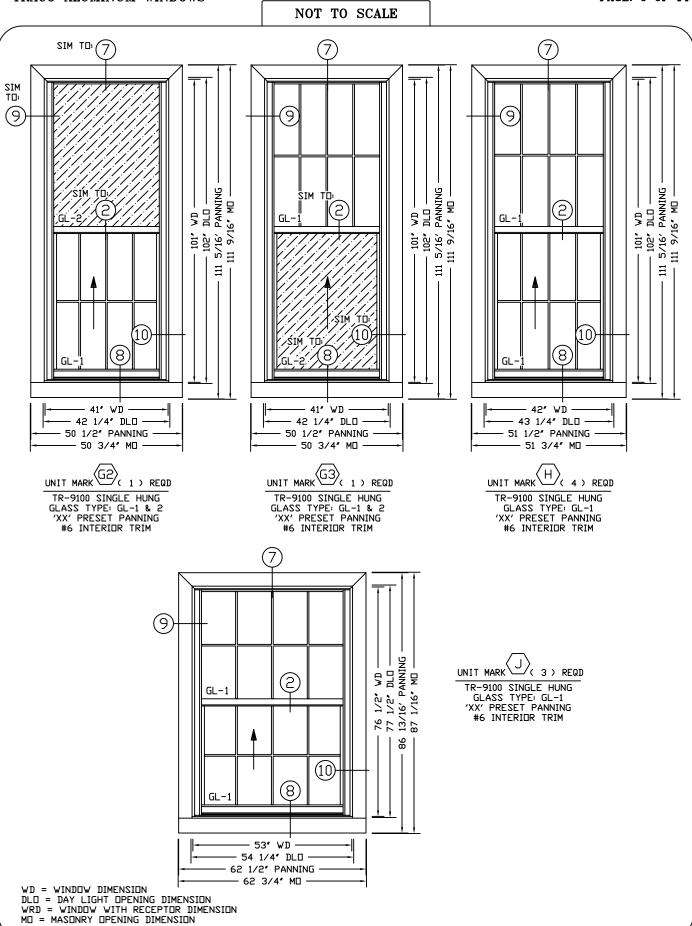



DATE: 8/9/10 PAGE: 7 OF 14

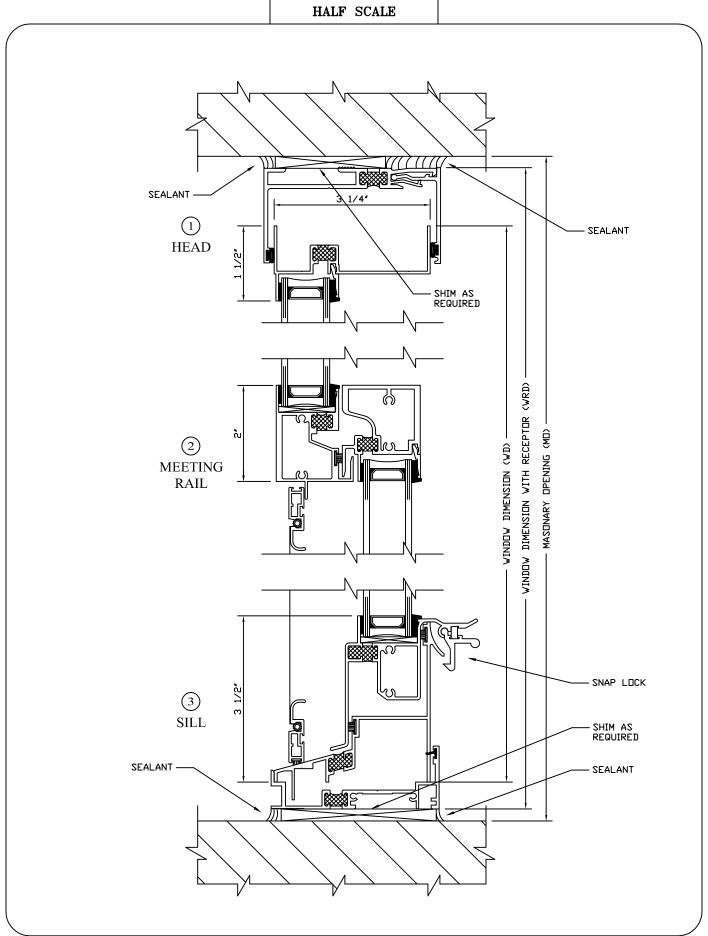



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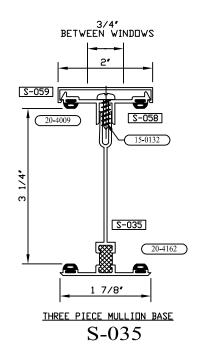





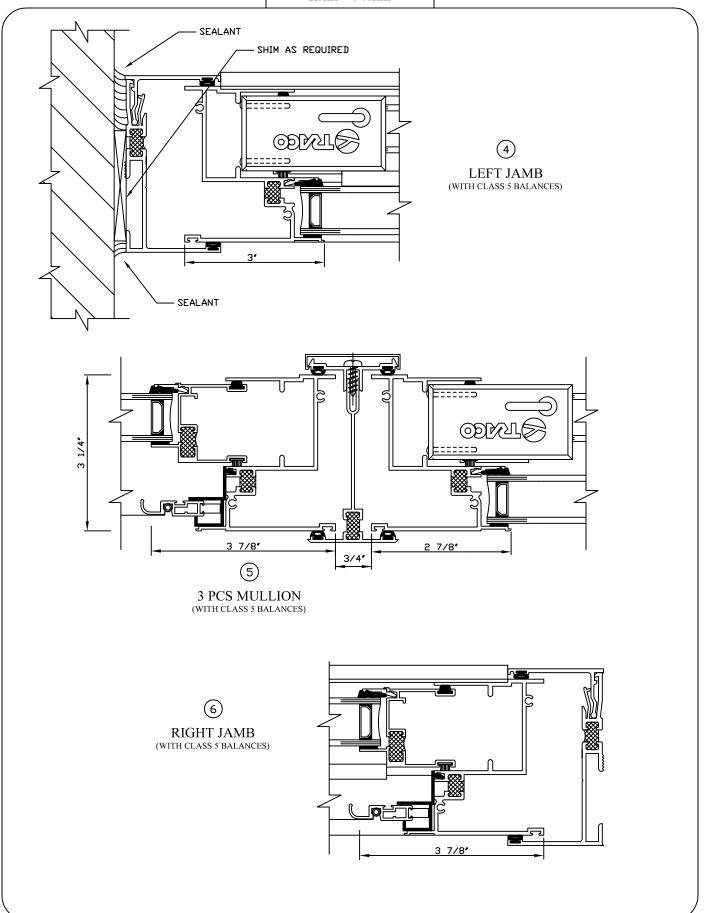


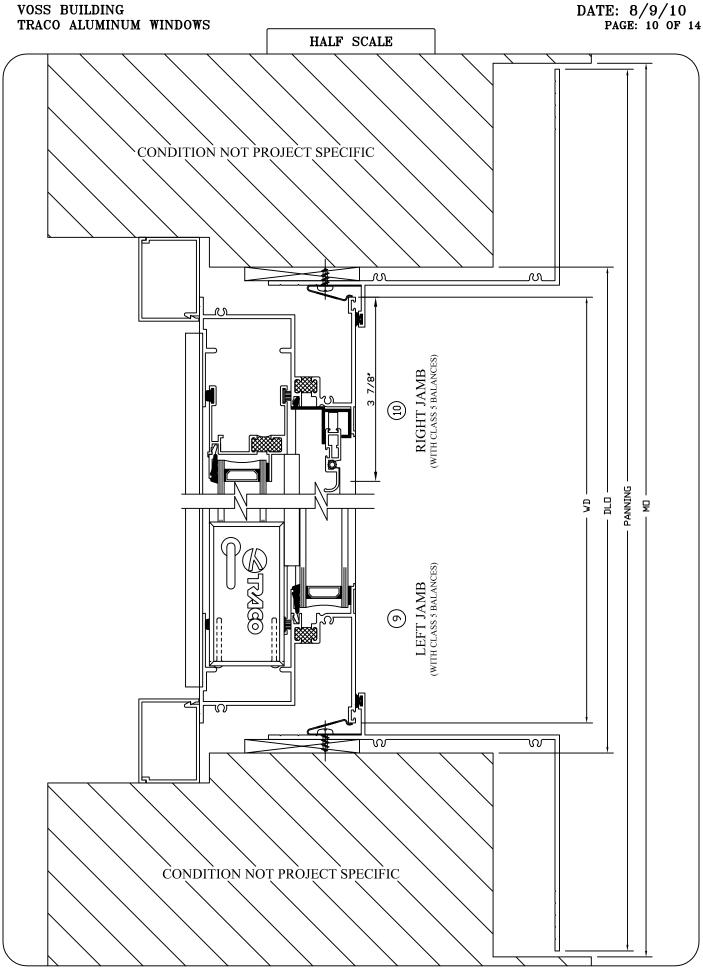


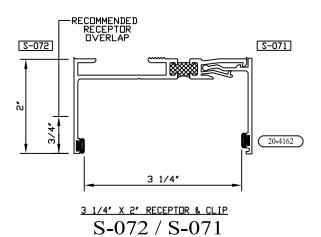

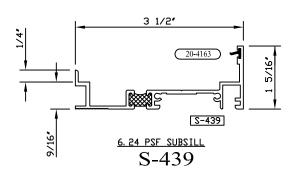


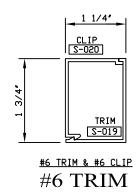

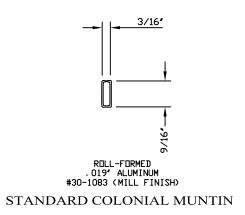

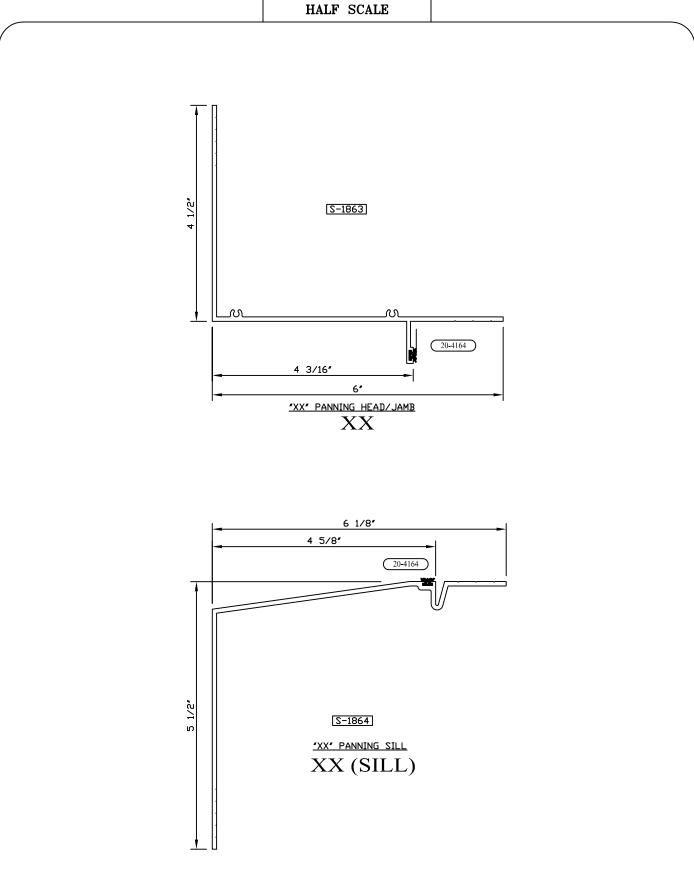

HALF SCALE

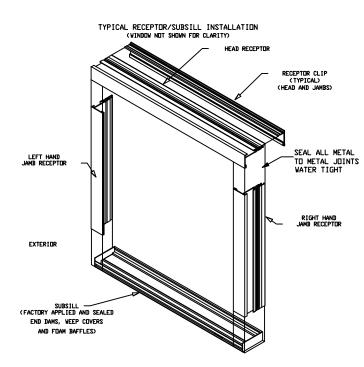

ASSEMBLY PROCEDURE:

- 1. CUT HEAD RECEPTOR TO OPENING WIDTH, AND FASTEN TO OPENING HEAD.
- 2. CUT JAMB RECEPTORS TO FIT FROM HEAD RECEPTOR DOWN-TURNED LEG TO SILL.


DATE: 8/9/10 PAGE: 13 OF 14

- 3. SET SUBSILL INSIDE JAMB RECEPTORS.
- 4. SEAL HEAD TO JAMB RECEPTOR METAL TO METAL JOINTS.
- 5. SET WINDOW INTO SYSTEM. THE SUBSILL MUST BE SEALED TO THE WINDOW UNIT THE COMPLETE LENGTH ON THE EXTERIOR. ALSO, THE INTERIOR SIDE OF THE SUBSILL MUST BE SEALED AT ANY LOCATION THAT THE WEDGE GASKET TERMINATES.
- 6. SNAP ON INTERIOR CLIPS TO RETAIN PRODUCT.


TYPICAL BRAKEMETAL END DAM

1' AS SHOWN.

- CUT BRAKEMETAL TO FIT ROUGH OPENING(SHIM AS REQ'D)
- COPE BACK LEG OF BRAKEMETAL
- 3. LOCATE ANGLE (SET IN SEALANT) 7. SEAL THOURDUGHLY BETWEEN BACK
- SEAL ALONG ANGLE FACE AND LEG AT BRAKEMETAL GENEROUSLY.
- 5. LOCATE AND INSTALL EXTERIOR RECEPTOR. ANCHOR PROPERLY.
- 6. SEAL ALONG ANGLE AND RECEPTOR EXTERIOR FACE.
- OF ANGLE AND RECEPTOR TO TOP OF ANGLE. REFER TO JAMB DETAIL TR PLAN VIEW.
- 8. NOTE: SIMILAR WITHOUT RECEPTOR.

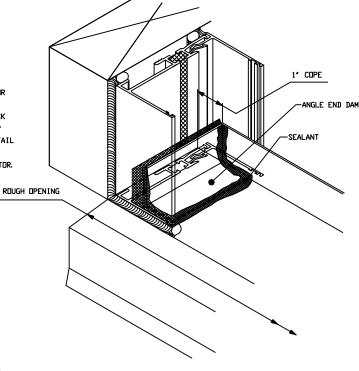


SUBSILL-TO-RECEPTOR JAMBS

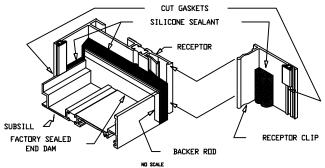


DATE: 8/9/10 PAGE: 14 OF 14




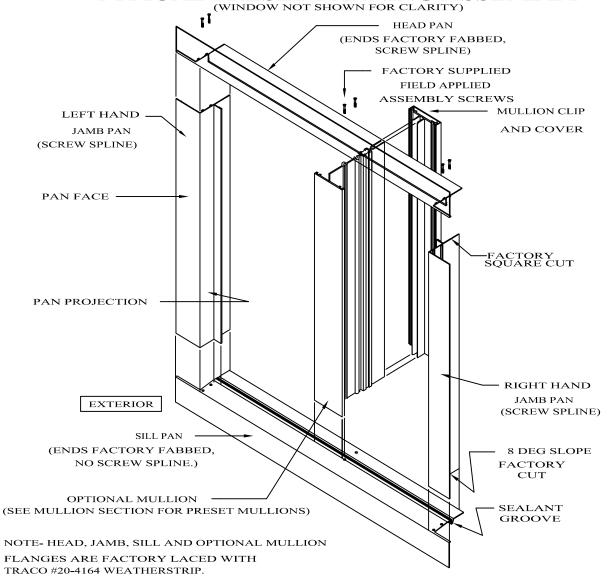


Wojan Window Type 3

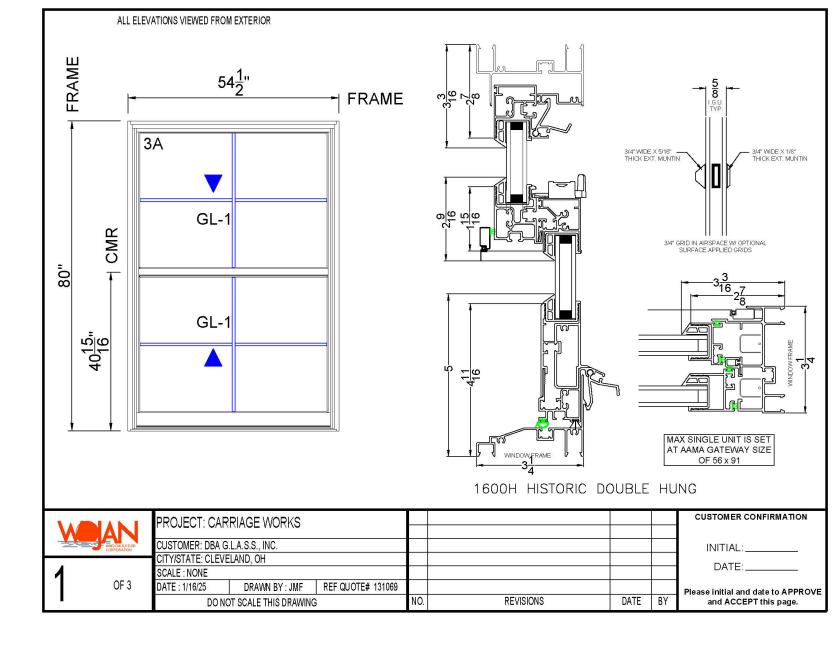

Wojan Window Type 3

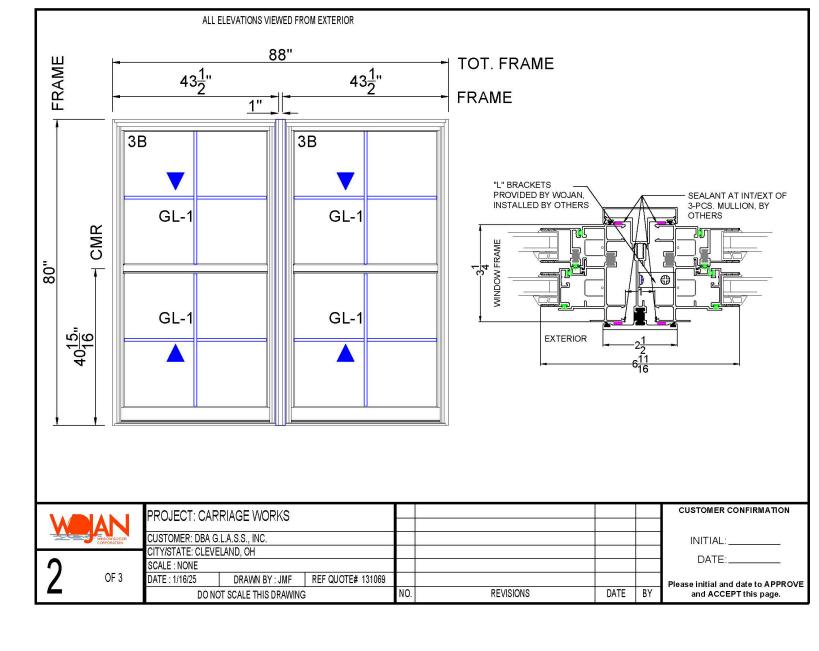

Wojan Window Type 3

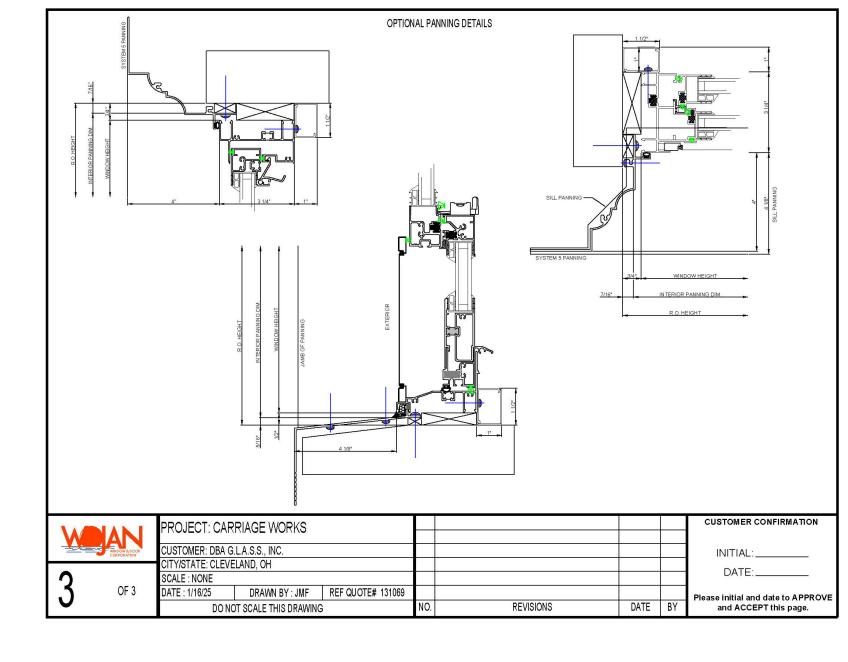

Window Type 5 - Kawneer

AA®5450 Ultra Thermal Window

DOUBLE HUNG WINDOW


22

EC 97911-331

DECEMBER 2024

15 PSF sill also available for use with panning.

Additional information and CAD details are available at www.kawneer.com

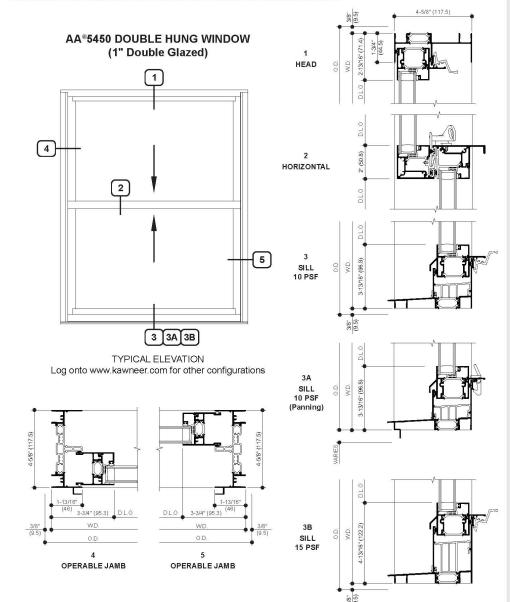

20

AA®5450 Ultra Thermal Window


DOUBLE HUNG WINDOW

DECEMBER 2024

EC 97911-331

Standard Features

- · High Performance Architectural Grade Window
- · Tested to U.S. and Canadian Standards
- · Polyamide Thermal Break
- · Screw and Spline Frame Corner Joinery
- · Factory Silicone Glazed
- · Interior Applied Glazing Bead
- · Architectural Anodized Finishes and Applied Coatings
- · Interior and Exterior Dual Finish Options
- · Two Year Manufacturer's Warranty
- · Optional Bevel Face

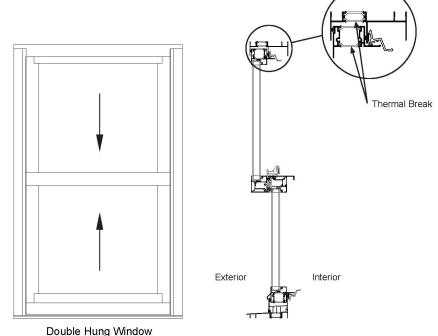

For specific product applications, consult your Kawneer representative.

Window Type 5 - Kawneer

DECEMBER 2024 EC 97911-331

AA®5450 Ultra Thermal Window

DOUBLE HUNG WINDOW


Kawneer reserves the right to change configuration without prior no necessary for product improvement.

2014, Kawneer Company, Inc.

CLASS and GRADE	CLASS AW-PG65-H
TESTING METHOD	AAMA / WDMA / CSA / 101 / I.S.2 / A440 (NAFS)
FRAME DEPTH	4-5/8" Overall Frame Depth
TYPICAL WALL THICKNESS	.070" Nominal
TYPICAL MAXIMUM WINDOW SIZE	60" x 99"
TYPICAL MINIMUM WINDOW SIZE	24" x 36"
TYPICAL CONFIGURATIONS	+ + + + + + + + + + + + + + + + + + + +
STANDARD INFILL OPTIONS	1" and 1-1/2"
STANDARD HARDWARE	Heavy Duty Balances Zinc Die Cast Sweep Locks Sash Stops Aluminum Upper Sash Auto Lock
OPTIONAL HARDWARE	Aluminum or White Bronze Sill Auto Locks
OTHER OPTIONS	Between the Glass Muntins Historic Beveled Exterior Glazed-in Muntins (1-1/2" max. overall thickness) Exterior and Interior Tape Applied Muntins Perimeters and Sills Exterior Pannings and Interior Trims True Intermediate Muntin Structural Mullions Male/Female horizontally stacked H-Mullion for vertical stacking Strap Anchors



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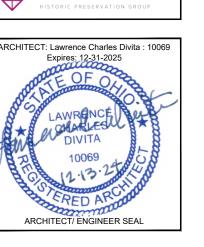
LANDSCAPE ARCHITECT:
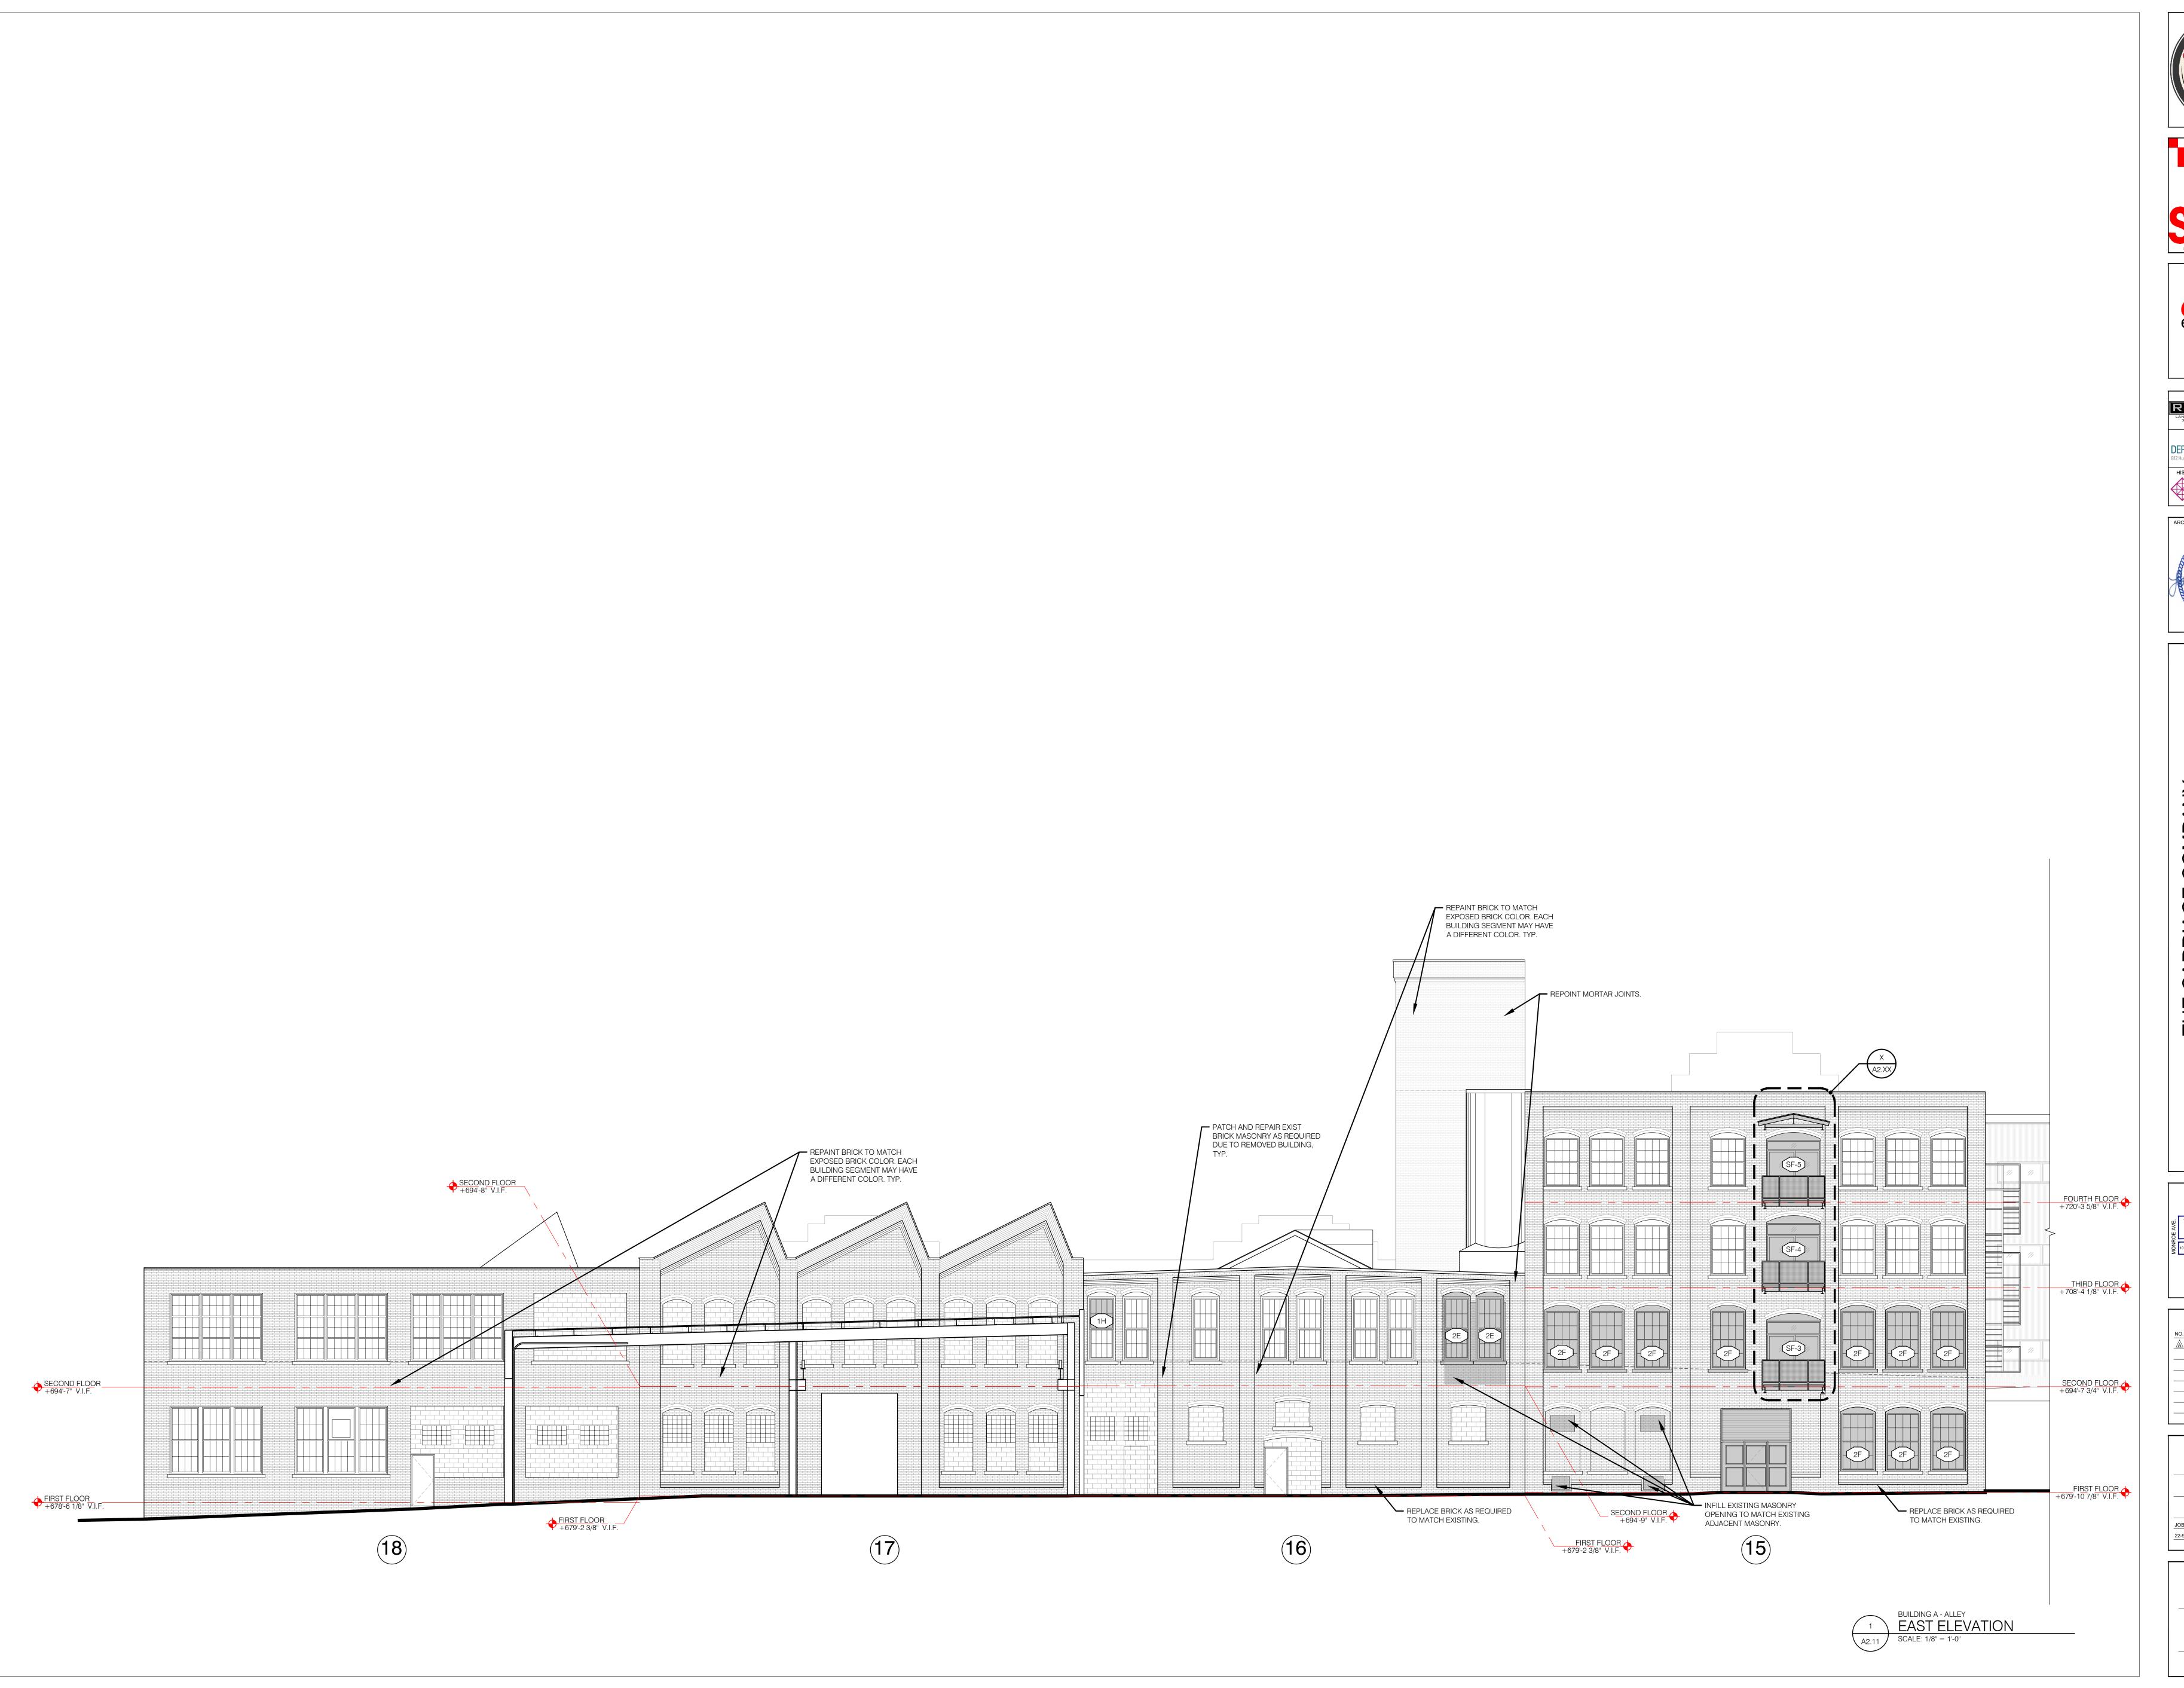
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HISTORIC RESTORATION CONSULTANT:

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HISTORIC PRESERVATION GROUP



HISTORIC RENOVATION
PROJECT NAME

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LOCATION

| REVISION HISTORY:

NO.	PURPOSE OF ISSUE	DATE				

DRAWING TITLE:

EAST

ELEVATION

A - ALLEY


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EAST

ELEVATION

B - ALLEY

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A2.12

BUILDING B - ALLEY

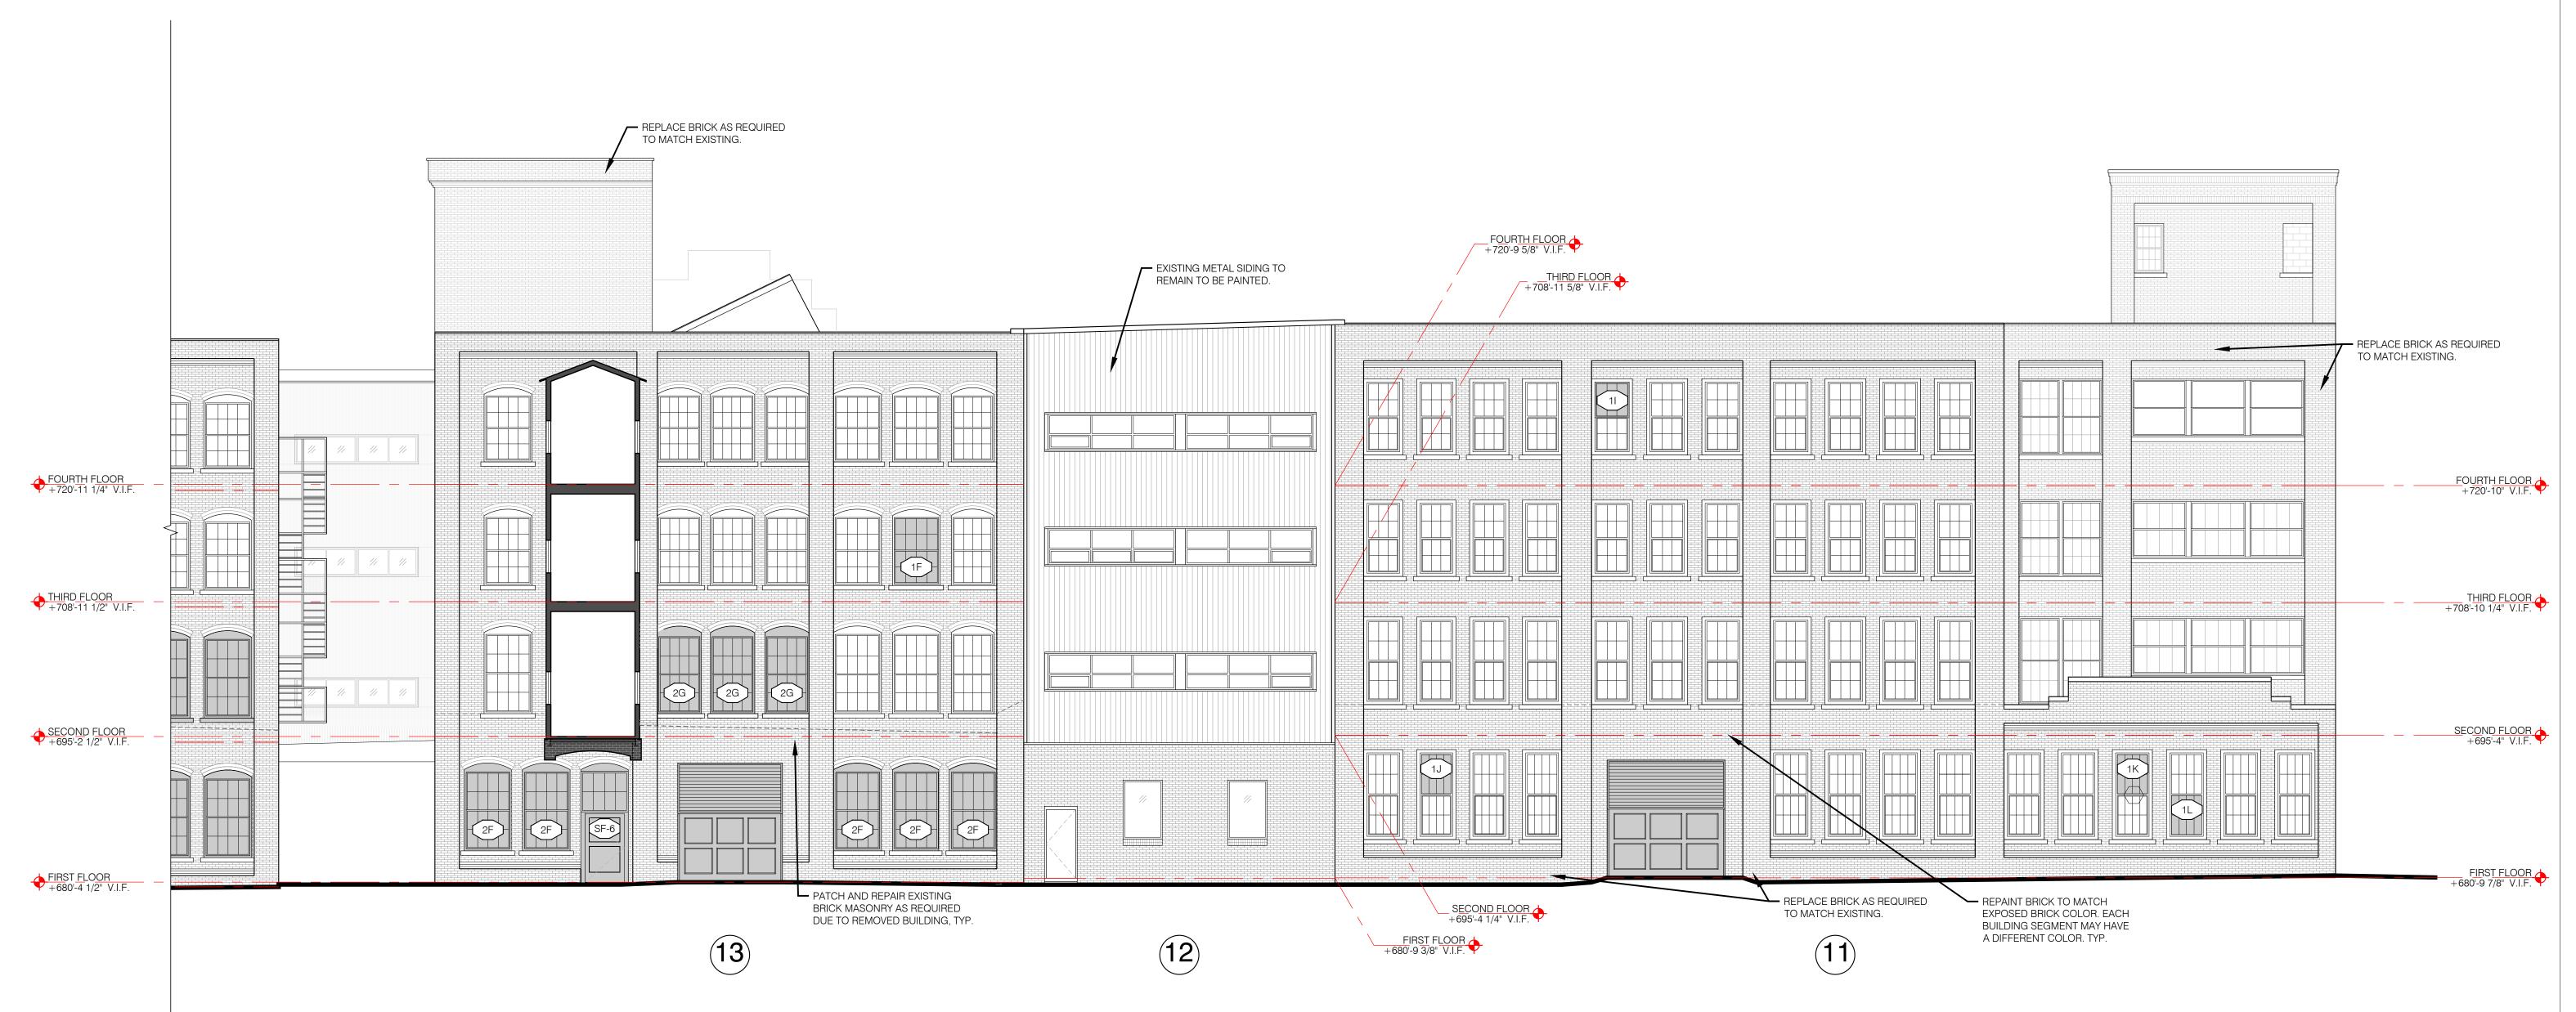EAST ELEVATION

SCALE: 1/8" = 1'-0"

A2.1

ISSUE:









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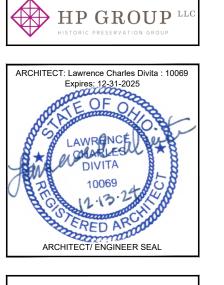
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EAST

ELEVATION

C - STREET

JOB# | DRAWN BY: | REVIEWED BY:
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A2.13

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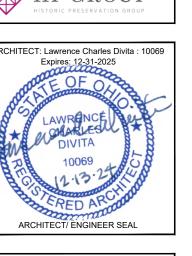
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| KEY MAP | W 26TH STREET | 18 | 17 | 16 | 15 | 14 | 13 | 11 | **B** | WYLLY | WYLLY | W 25TH STREET | W 25TH STREET | N

DRAWING TITLE:

EAST

ELEVATION

D - STREET

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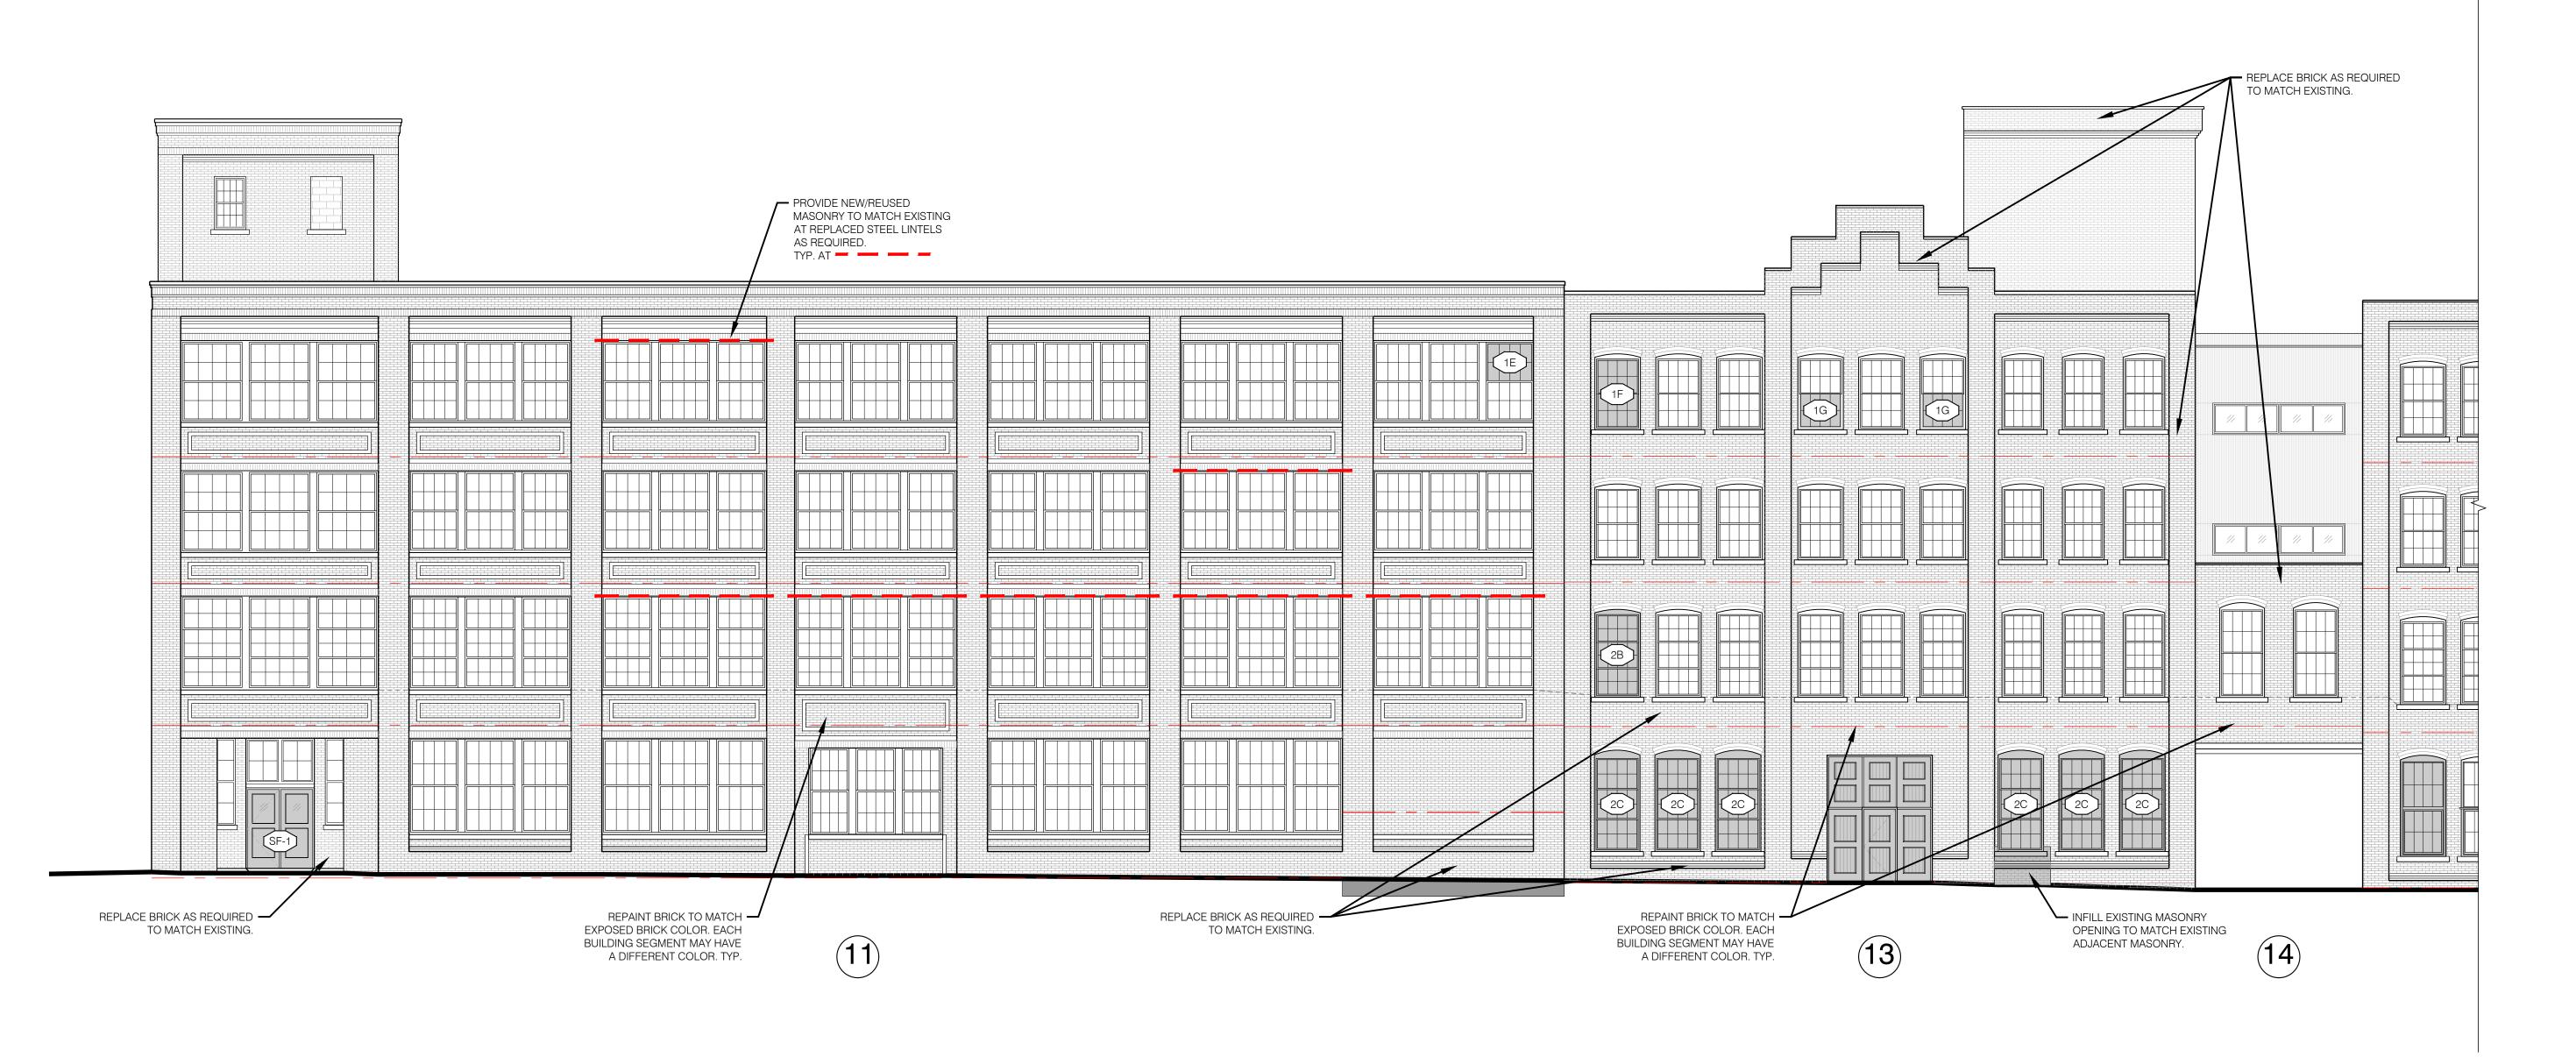
A - STREET

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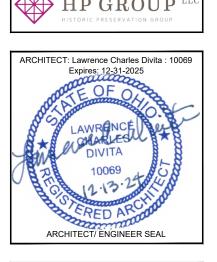
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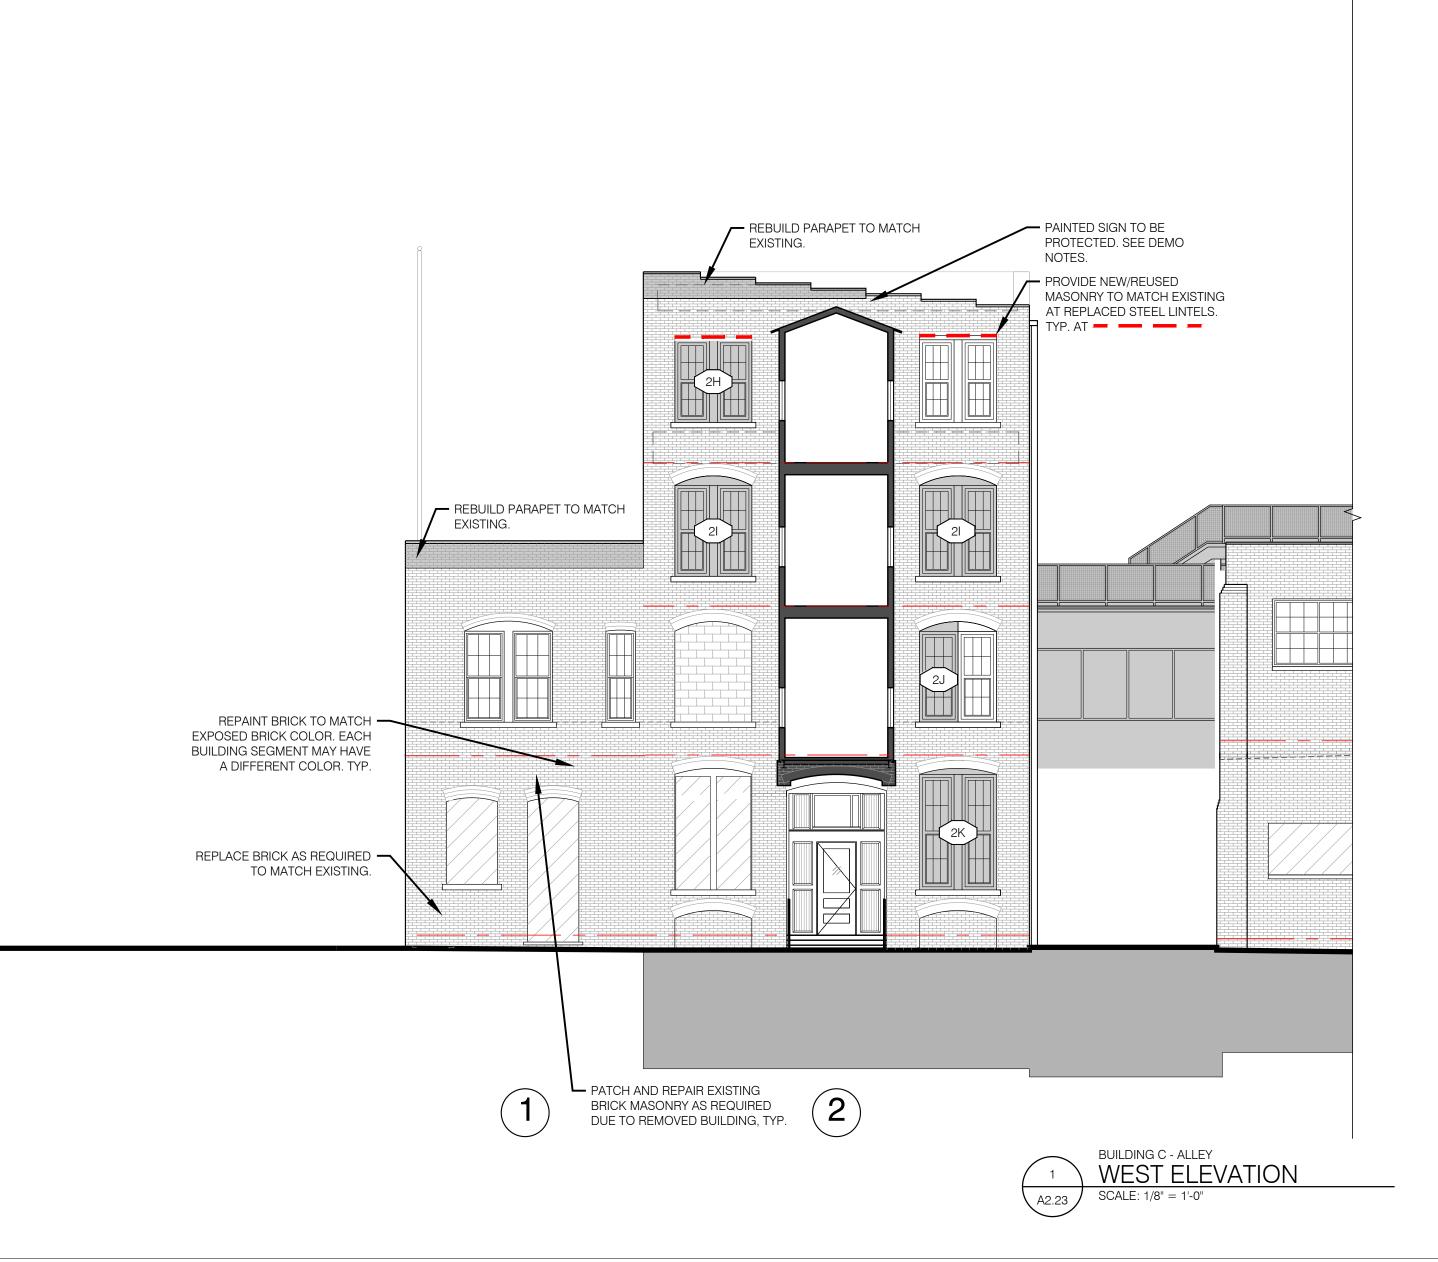
B - STREET

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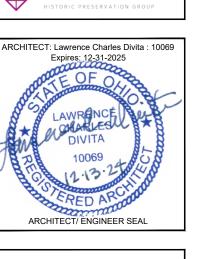
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LOCATION

| KEY MAP | W 26TH STREET | B | W 4 | B | W 4 | B | W

2168

DRAWING TITLE:

WEST

ELEVATION


C - ALLEY

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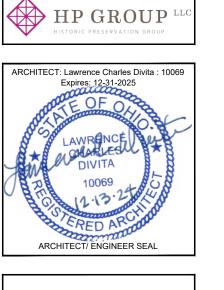
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DRAWING TITLE:

WEST

ELEVATION

D - ALLEY

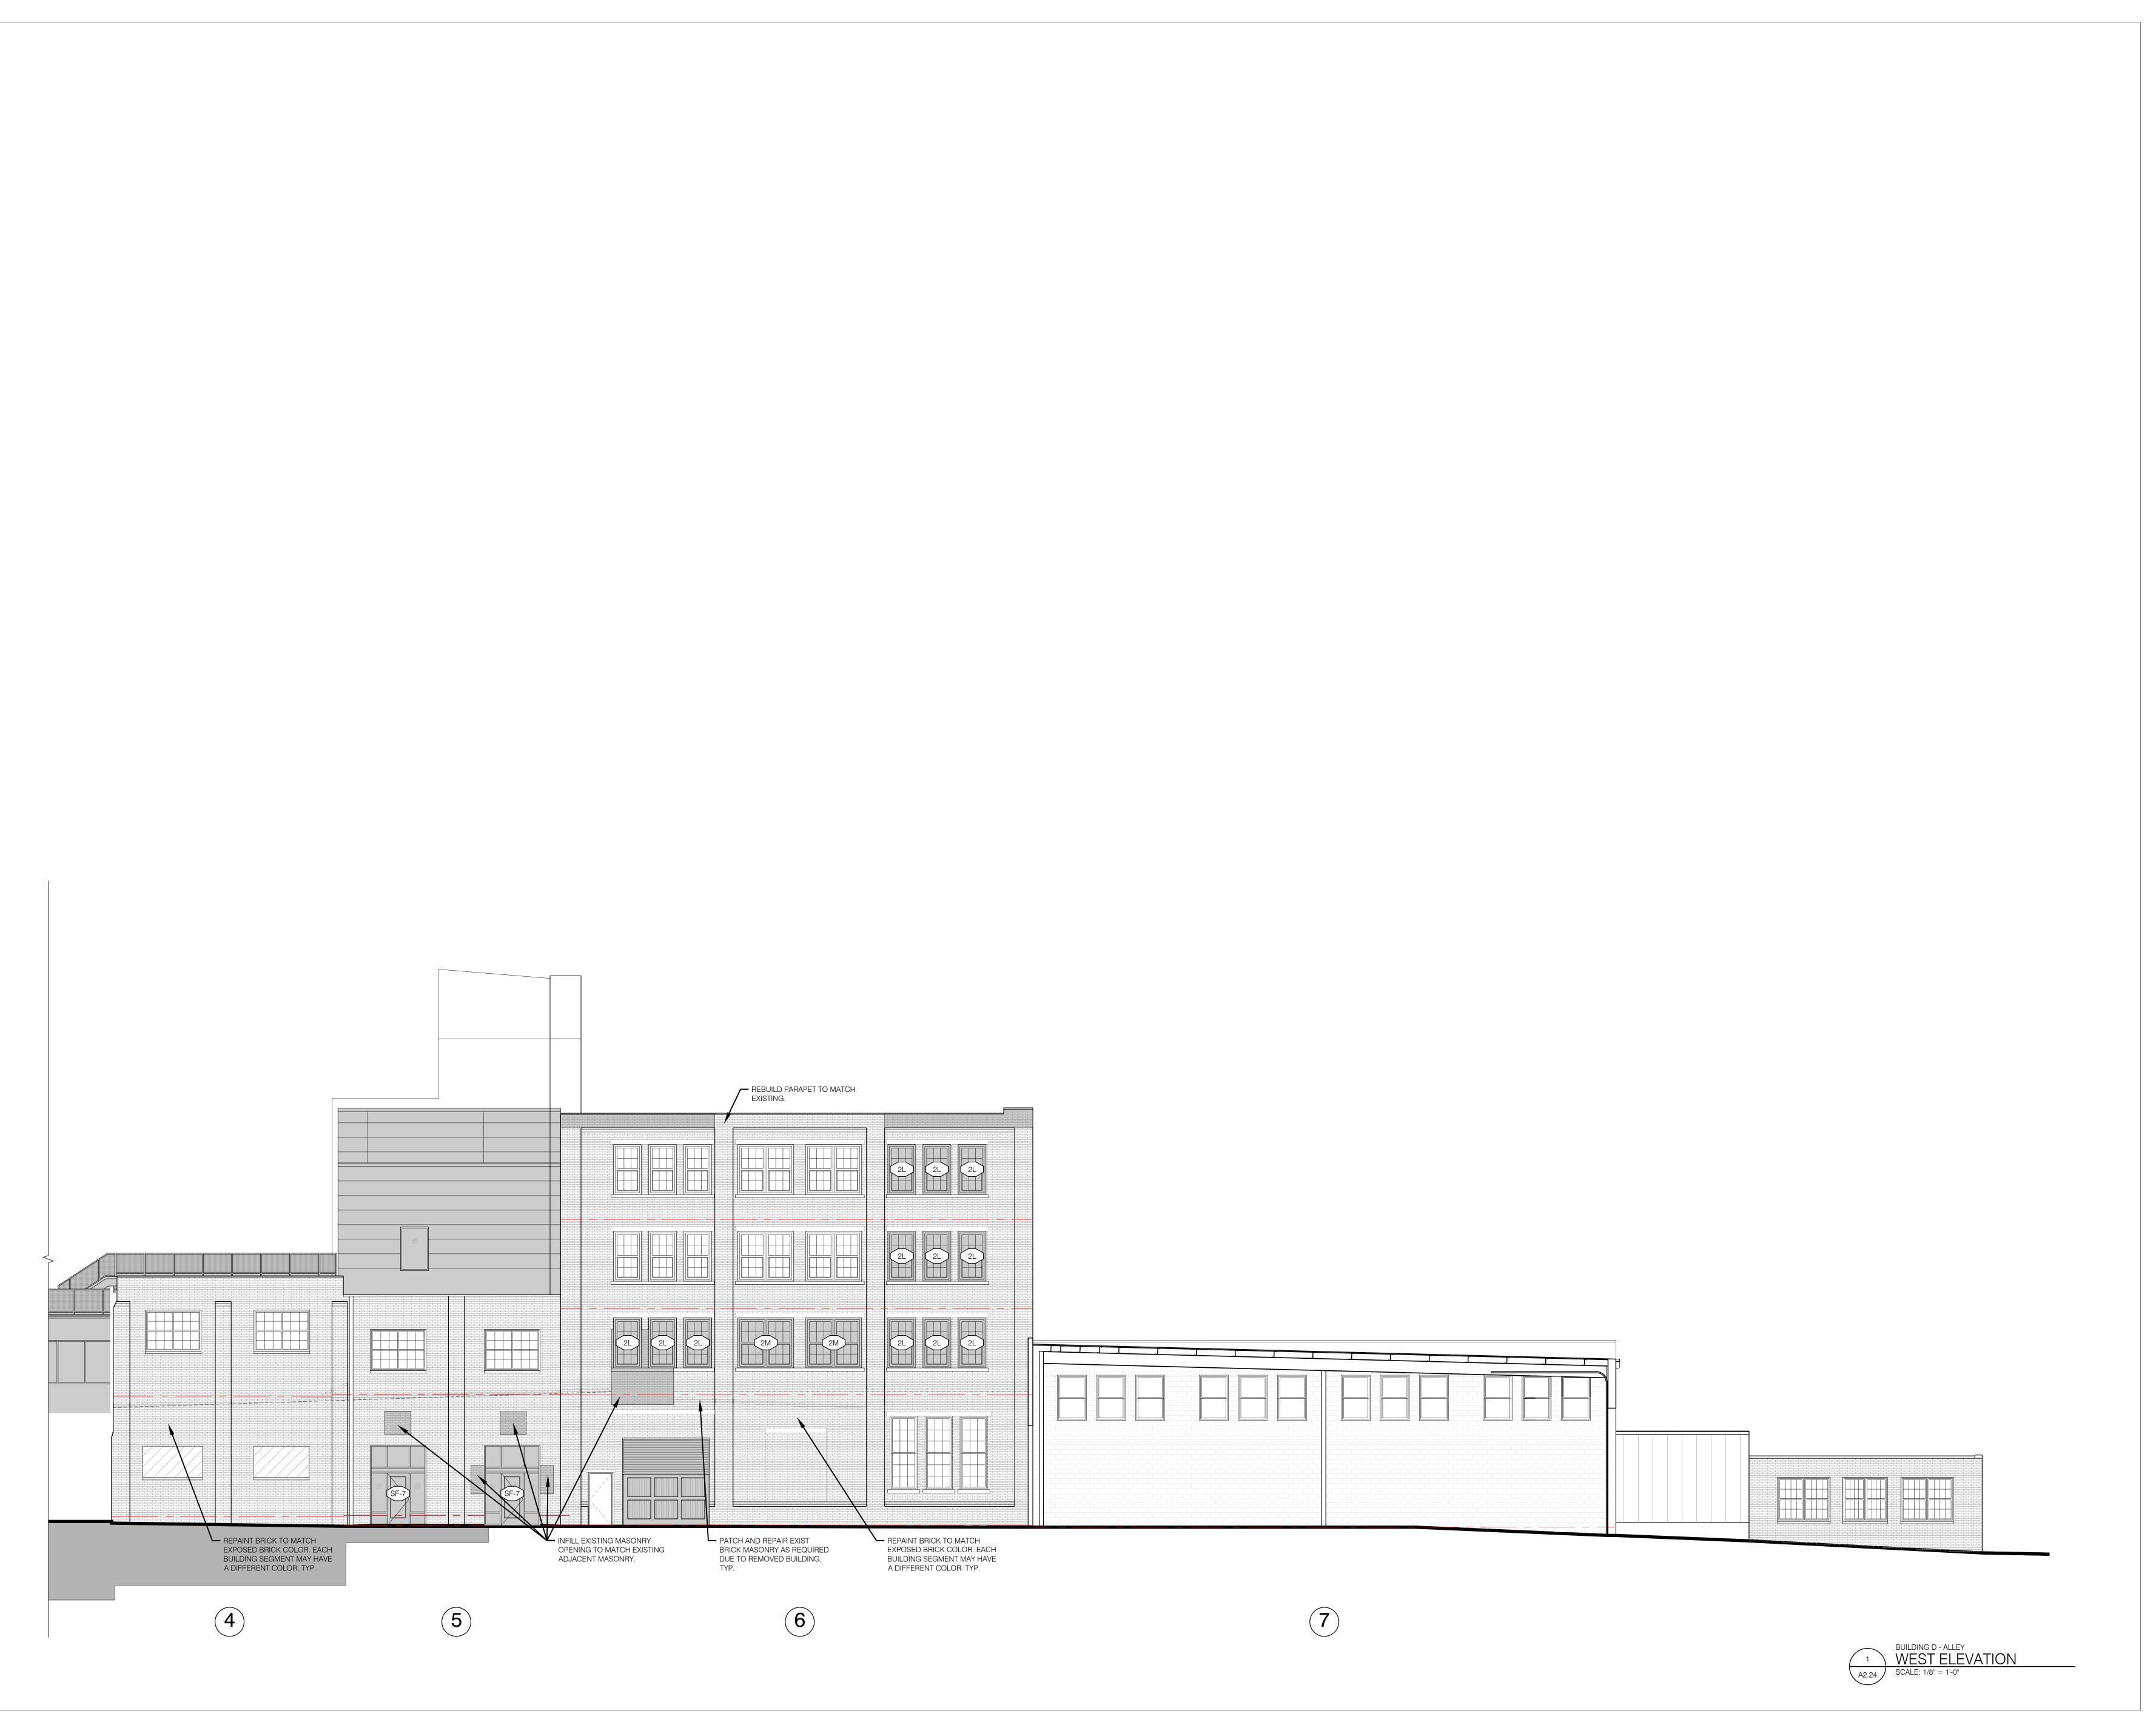DRAWING NUMBER:

A2.24

ISSUE:

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> KEY MAP W 26[™]STREET W 25[™]STREET

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DRAWING TITLE: NORTH ELEVATION BB&C - STREET

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DRAWING NUMBER:

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A2.31 ISSUE: Α




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W 26[™]STREET W 25[™]STREET

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DRAWING TITLE: NORTH **ELEVATION** BA&D - ALLEY

DRAWING NUMBER:

JOB# | DRAWN BY: | REVIEWED BY:
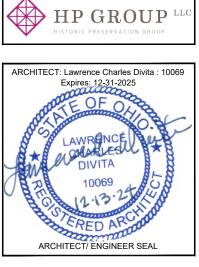
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A2.32 ISSUE:

BUILDING A&D - ALLEY
NORTH ELEVATION

SCALE: 1/8" = 1'-0"

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DRAWING TITLE:

SOUTH

ELEVATION

BB&C - ALLEY

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DRAWING NUMBER:

A2.41


BUILDING B&C - ALLEY
SOUTH ELEVATION

SCALE: 1/8" = 1'-0"

11-1/3-24





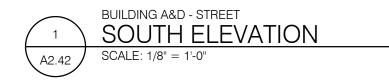



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CIVIL ENGINEER

LAND SURVEYING - ENGINEERING - DESIGN 3B00 LAKESIDE AVENUE - SUITE 100 WWW.RIVERSTONESURVEY.COM


LANDSCAPE ARCHITECT:

DERULandscape architecture
812 Huron Road E, #411 Cleveland. OH 44115 | 216.466.4355

HISTORIC RESTORATION CONSULTANT:

HP GROUP

HISTORIC PRESERVATION GROUP

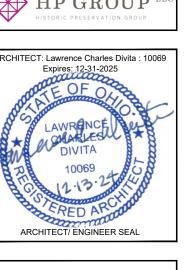

THE CARRIAGE COMPANY

CLIENT/OWNER

HISTORIC RENOVATION

PROJECT NAME

2168 W. 25th ST | Cleveland, Ohio 44113
LOCATION

SOUTH

ELEVATION


BA&D - STREET

JOB# | DRAWN BY: | REVIEWED BY:


A2.42


22-975 | TS | LD


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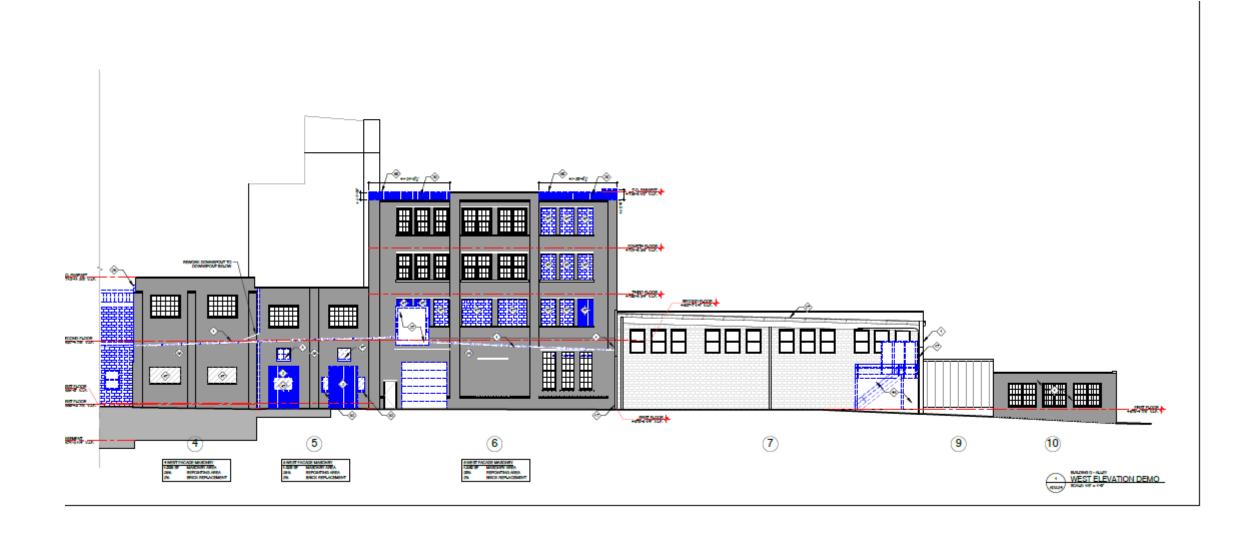


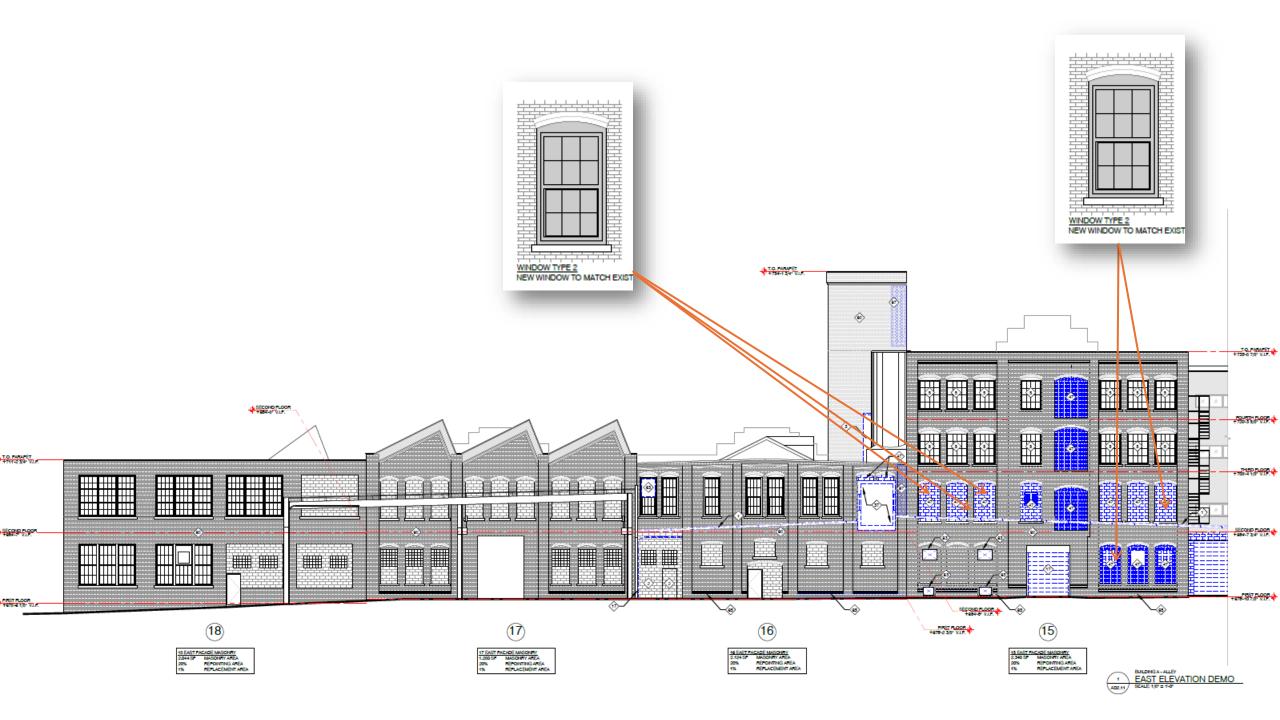





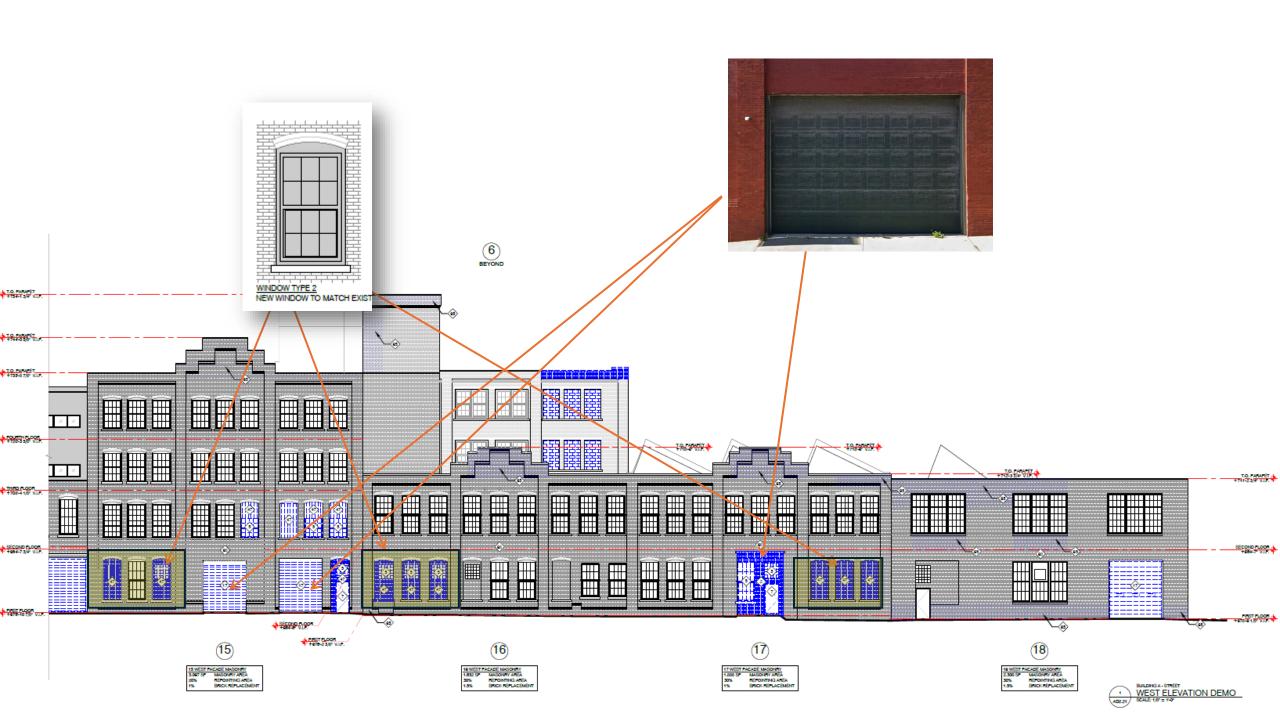

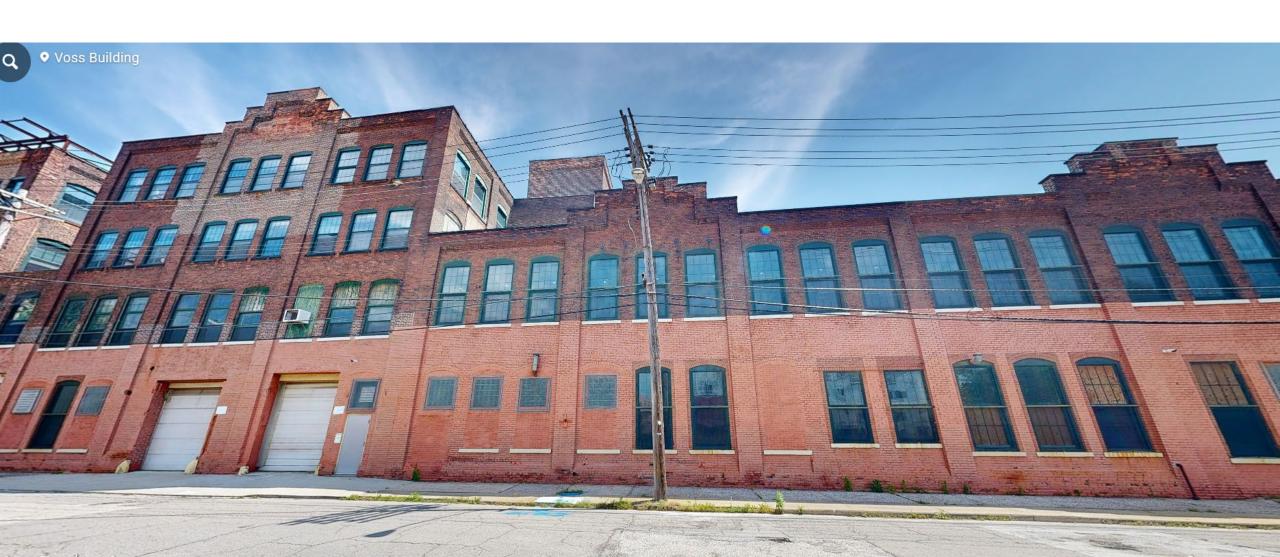


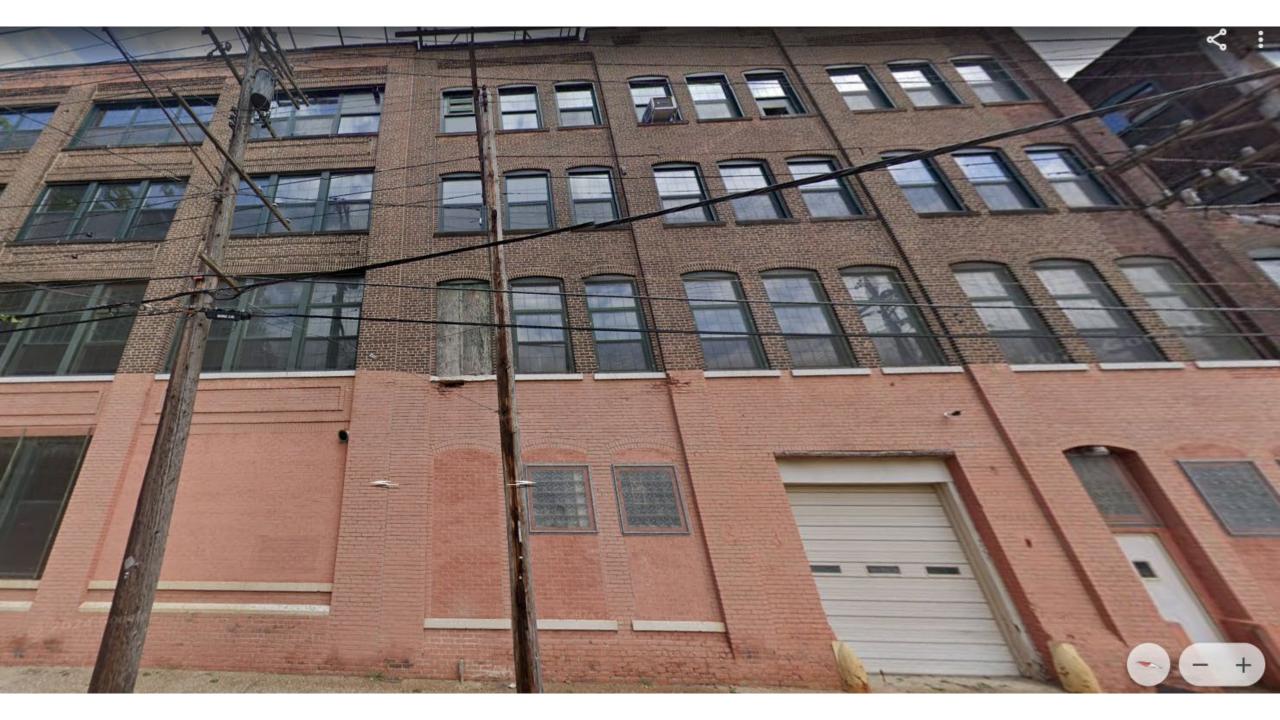

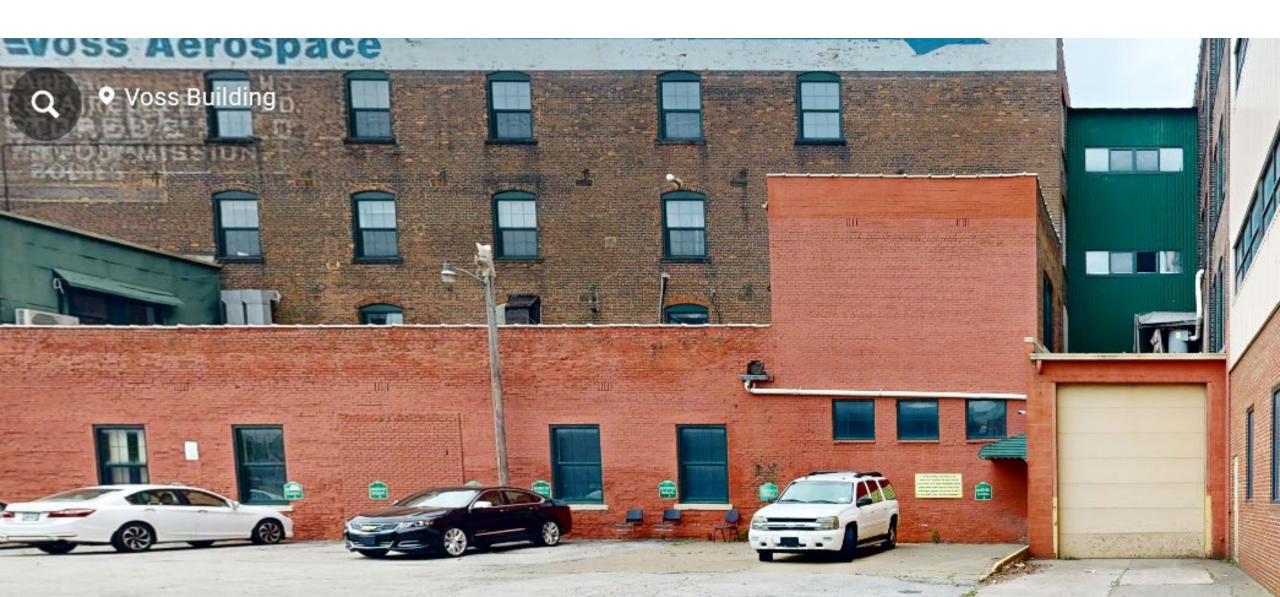

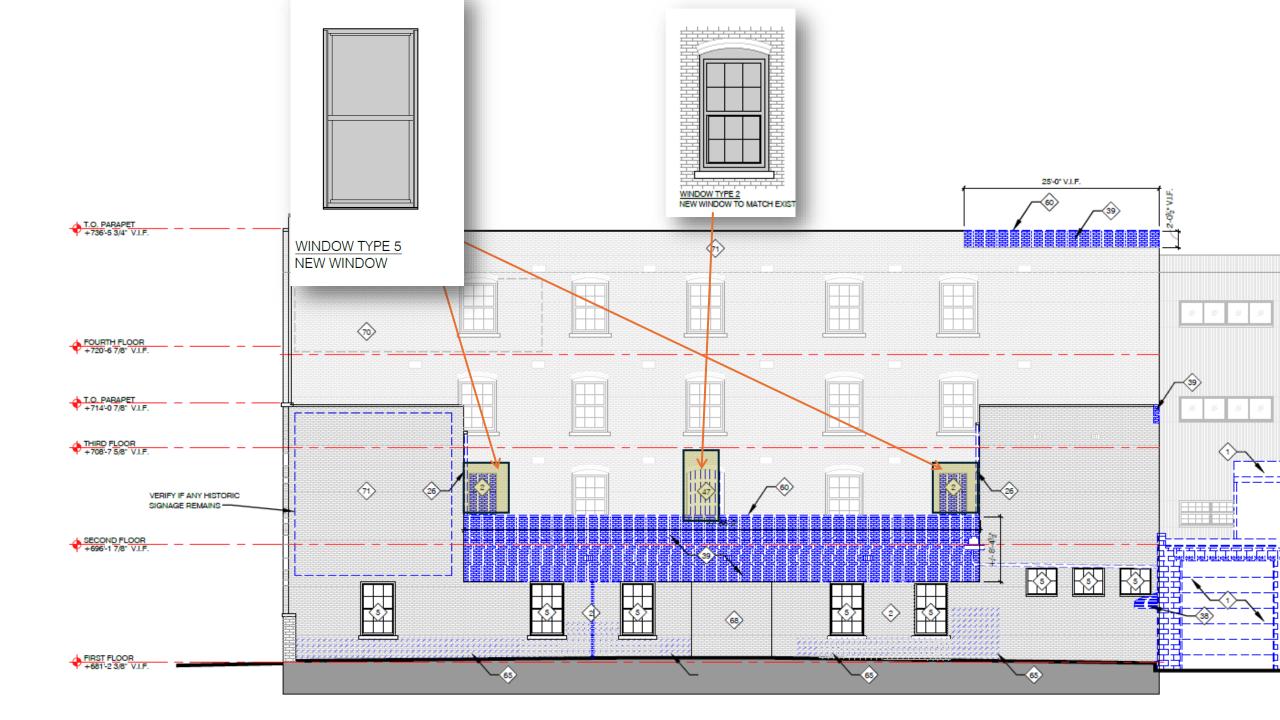



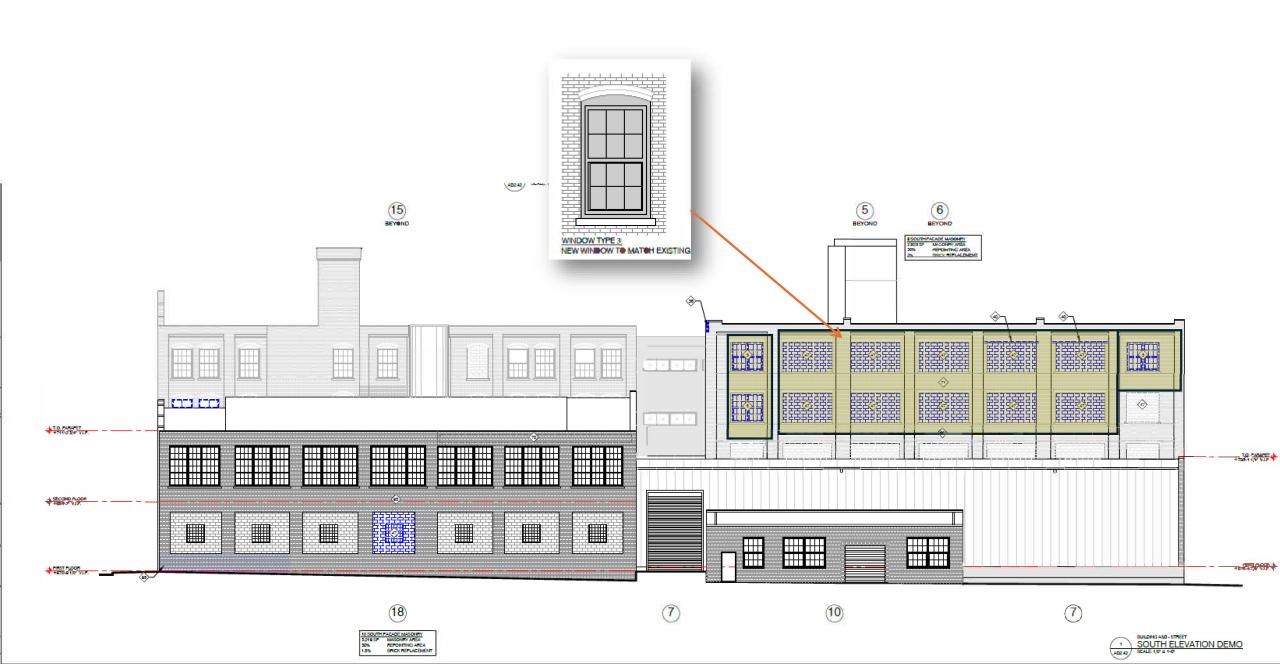

Case 25-008

Certificate of Appropriateness

Lorain Avenue Historic District

4810 Lorain Avenue

Demolition

Project Representatives: Kurt Weaver, Architect

Ward 3: Councilmember McCormack





4810 Lorain Avenue

Cleveland, Ohio

LANDMARKS PRESENTATION

PROPOSED

REPLACEMENT OFFICE

Request for Demolition ONLY



Cleveland, Ohio

proposed Replacement Office

January 30, 2025


MAP showing LOCATION

THE SUBJECT PROPERTY IS LOCATED ON THE NW CORNER OF LORAIN AVENUE & WEST 48th STREET.

THIS IS A BUSY LOCATION WITH THE URBAN SCHOOL ACROSS THE STREET.

THE SITE CONTAINED A n. 80' x 133' SINGLE STORY MASONRY BEARING WALL STRUCTURE OF n. 10,640 S.F. THE STRUCTURE INCLUDED A STRUCTURAL STEEL SUPPORTED MEZZANINE & STEEL FRAME METAL ROOF.

THE STRUCTURE WAS COMPLETELY DESTROYED IN A FIRE EVENT THAT OCCURRED IN EARLY DECEMBER 2024.

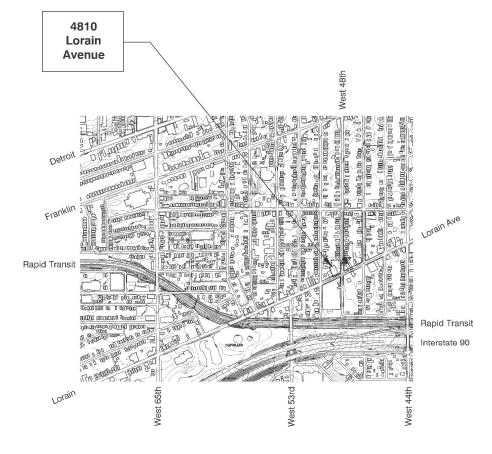





Cleveland, Ohio

proposed Replacement Office

January 30, 2025

HISTORY of the BUILDING / SITE

THE CUYAHOGA COUNTY AUDITOR'S WEBSITE PROVIDES THE FOLLOWING INFORMATION OF THE PROPERTY:

PPN: 002 - 34 - 074

4810 LORAIN, LLC 4810 LORAIN AVENUE CLEVELAND, OHIO 44102

ONE STORY
BUILT IN 1963
FIRE RESISTANT FRAMING, CNC BLK
720 S.F. OFFICE
CONSTRUCTION CLASS C
USABLE AREA: 10,480 S.F.
DATE REMODELED 1971
ROOFING TYPE: GABLE
MEZZANINE AREA: 3,920 S.F.
HEAT TYPE: FORCED AIR
SLAB ON GRADE
CONDITION: AVERAGE
ROOF COVERING: COMPOSITION





4810 Lorain

Cleveland, Ohio

BLDG

CURRENT IMAGES of the PROPERTY & **SURROUNDINGS**

SOUTH Lorain Avenue **ELEVATION**

proposed Replacement Office

January 30, 2025



4810 Lorain Cleveland, Ohio

proposed Replacement Office

January 30, 2025

BLDGCURRENT IMAGES of the PROPERTY &

SURROUNDINGS

EAST ELEVATION





4810 Lorain

Cleveland, Ohio

BLDG

CURRENT IMAGES of the PROPERTY & SURROUNDINGS

NORTH ELEVATION Looking from the NE

proposed Replacement Office

January 30, 2025





4810 Lorain

Cleveland, Ohio

proposed Replacement Office

January 30, 2025

BLDG

CURRENT IMAGES of the PROPERTY & SURROUNDINGS

NORTH portion of WEST ELEVATION





Cleveland, Ohio

proposed Replacement Office

January 30, 2025

DETAIL

DETAIL IMAGES of the DAMAGED STRUCTURE

SOUTH ELEVATION:

WEST BLDG FAÇADE PORTION





Cleveland, Ohio

DETAIL

DETAIL IMAGES of the DAMAGED STRUCTURE

EAST ELEVATION:

SOUTH PORTION

FRONT ROOF

proposed Replacement Office

January 30, 2025





Cleveland, Ohio

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January 30, 2025

DETAIL

DETAIL IMAGES of the DAMAGED STRUCTURE

NORTH ELEVATION:

WEST OVERHEAD DOOR





Cleveland, Ohio

proposed Replacement Office

January 30, 2025

DETAIL

DETAIL IMAGES of the DAMAGED STRUCTURE

NORTH ELEVATION:

EAST PORTION





Cleveland, Ohio

CONTEXT

IMAGES of the SURROUNDING NEIGHBORHOOD

ADJACENT WEST:

2 STORY PERIOD STRUCTURE; STOREFRONT BELOW, APARTMENT(S) ABOVE

proposed Replacement Office

January 30, 2025





Cleveland, Ohio

proposed Replacement Office

January 30, 2025

CONTEXT

IMAGES of the **SURROUNDING NEIGHBORHOOD**

OPPOSITE EAST:

2 STORY PERIOD STRUCTURE; STOREFRONT BELOW, APARTMENT(S) ABOVE





4810 Lorain Cleveland, Ohio

proposed Replacement Office

January 30, 2025

CONTEXT

IMAGES of the SURROUNDING NEIGHBORHOOD

OPPOSITE SOUTH & EAST:

METROHEALTH





CONTEXT

IMAGES of the SURROUNDING NEIGHBORHOOD

OPPOSITE SOUTH:

URBAN SCHOOL







Cleveland, Ohio

MEASURED SITE PLAN EXISTING CONDITIONS CONTEXT

AKW, Inc. Project. No. 2444
Drawing Set dated 07 Jan. 2025
Submitted for Building Permit:
1.8.2025

Record: B25000956

ARCHITECT KURT WEAVER

proposed Replacement Office



January 30, 2025

Cleveland, Ohio


SITE PLAN Preparation/ Selective **Demolition Plan**

INCLUDING SALVAGE PLAN:

THE FORMER STRUCTURE WILL BE REMOVED FLUSH TO GRADE, RETAINING THE EXISTING SLAB-ON-GRADE, AND EXISTING SUB-GRADE UTILITIES CONNECTIONS.

ALL STRUCTURAL STEEL & SALVAGE METAL WILL BE RECYCLED.



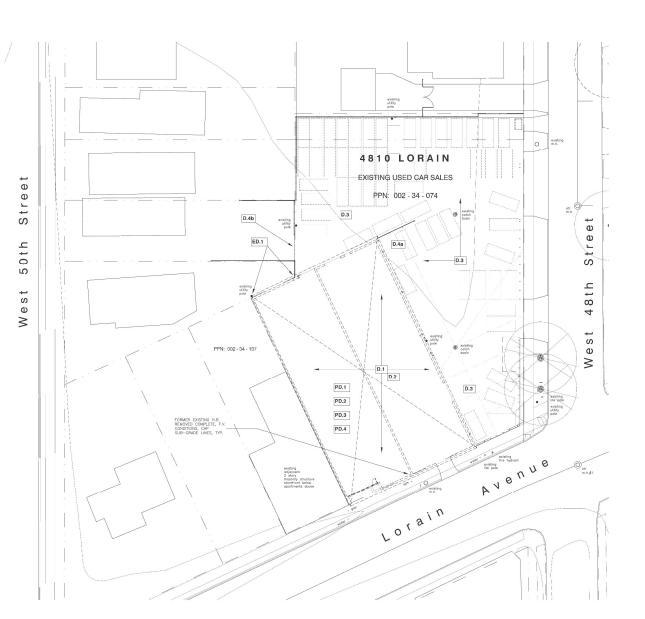

January 30, 2025

Cleveland, Ohio

PROPOSED SITE PLAN

THE OWNER PROPOSES AFTER REMOVAL OF THE DAMAGED STRUCTURE & CLEANING OF THE SITE, TO REINSTATE THE EXISTING USED CAR SALES OPERATIONS; REPLACING THE DESTROYED STRUCTURE WITH A PRE-FABRICATED MODULAR OFFICE STRUCTURE. THE NEW OFFICE WILL BE LOCATED TO TAKE ADVANTAGE OF THE EXISTING SITE SUBGRADE UTILITIES.


THE EXISTING PERIMETER FENCE (WHITE PANEL) WILL BE EXPANDED AS NECESSARY INCLUDING TRASH DUMPSTER ENCLOSURE.

THE EXISTING PERIMETER SITE BOLLARDS WILL BE EXTENDED ON THE NOW OPEN LORAIN AVENUE FRONTAGE.

SITE ACCESS WILL BE DESIGNATED INCLUDING VISITOR PARKING



proposed Replacement Office

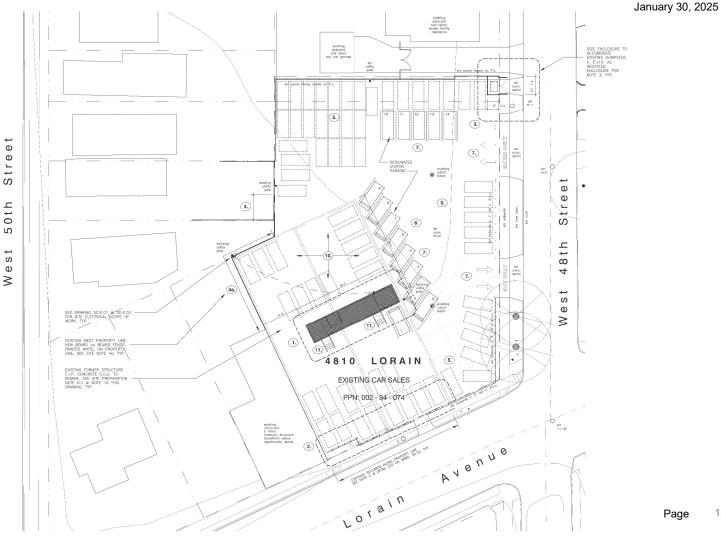

Page

18

4810 Lorain Cleveland, Ohio

proposed Replacement Office

January 30, 2025

Nia

LANDMARKS PRESENTATION

Tommy Sullivan, owner, client City of Cleveland, Landmarks Commission Ms. Jessica Beam (Beam-Wymer) Historic Ohio City Design Review Advisory Committee Daniel Musson Maura Flaherty Angelo Trivisonno Christopher Persons Margaret Lann Julia Mettles Grove Whitney Anderson Brant Miller

THANK YOU









Case 25-001

Certificate of Appropriateness

Franklin-West Clinton Historic District

Tabled January 23rd, 2025

5810 Franklin Boulevard

Window Replacement

Project Representatives: Josh Walczuk, Universal Window Direct Ward 15: Councilmember Spencer






Indian Delight | Cleveland, Ohio Enjoy Delicious Indian Food DETROIT -SHOREWAY Ellen Ave Bridge Ave Bridge Ave IELD St Fir Ave Forest City Shuffleboard Arena and Bar kefield Ave Cent's Pizza + Goods dison Ave **Bailey Ave** Bailey Ave W.65-Lorain M Lawn Ave Colgate Ave Northwest Fwy ASHBURY **TOWERS** Caribe Bruno's Ristorante Max'S. Hayes High School & Catering aurant 🚻 Clark Ave Clark Ave Clark Ave International Ba **Newcomers Academy**

5810 FRANKLIN BLVD CLEVELAND OHIO 44102

BY JOSH WALCZUK WITH UNIVERSAL WINDOWS DIRECT



UNIVERSAL WINDOWS DIRECT

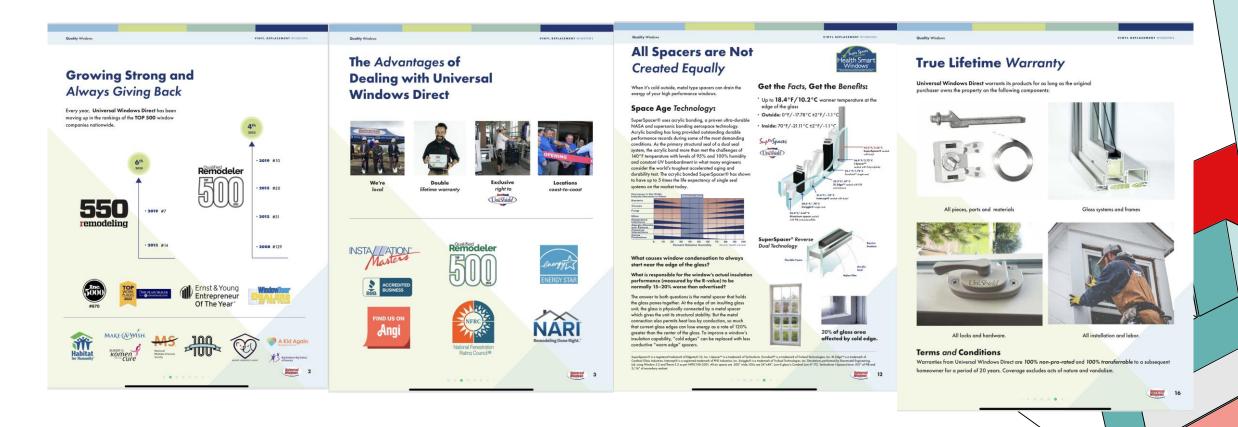

DOES IT MATCH THE NEIGHBORHOOD?

- Replacing 4 existing windows with 100% pure virgin vinyl Taylor fit custom replacements to match the existing openings and color.
- 2 of the windows are located on the 2nd level hallway of the property.

• 2 of the windows are located on the 2nd floor in the tenants unit causing high energy bills monthly.





- THE WINDOWS WILL BE WRAPPED WITH G8 PERFORMANCE ALUMINUM COIL FOR A CUSTOM CAP TO LOOK FLUSH WITH THE CURRENT EXTERIOR OF THE HOME.

• Example windows below,







-THE 4 WINDOWS WILL BE INSTALLED ON THE FRONT OF THE PROPERTY TO IMPROVE THE DRAFT IN THE EXISTING OPENINGS. THE WINDOWS ARE BEING INSTALLED IN THE HALLWAY ON THE 2ND FLOOR AND IN THE UPSTAIRS UNITS IN THE FRONT LIVING ROOM.

TO THE RIGHT ARE THE MEASUREMENTS OF THE WINDOW OPENINGS WE WILL BE DOING THE INSTALLATION FOR.



MATERIAL LIST WITH COLOR IMAGES

- All 4 windows will be white 100% pure virgin vinyl with a true life time warranty (100% non pro rated) and transferable to the next property owner for 20 years.

Exterior will be capped with g8 performance coil
with glacier white aluminum capping



WHAT IT COULD LOOK LIKE IF APPROVED!






THANK YOU

Josh Walczuk

330-321-6252

Josh.walczuk@uwdtba.com

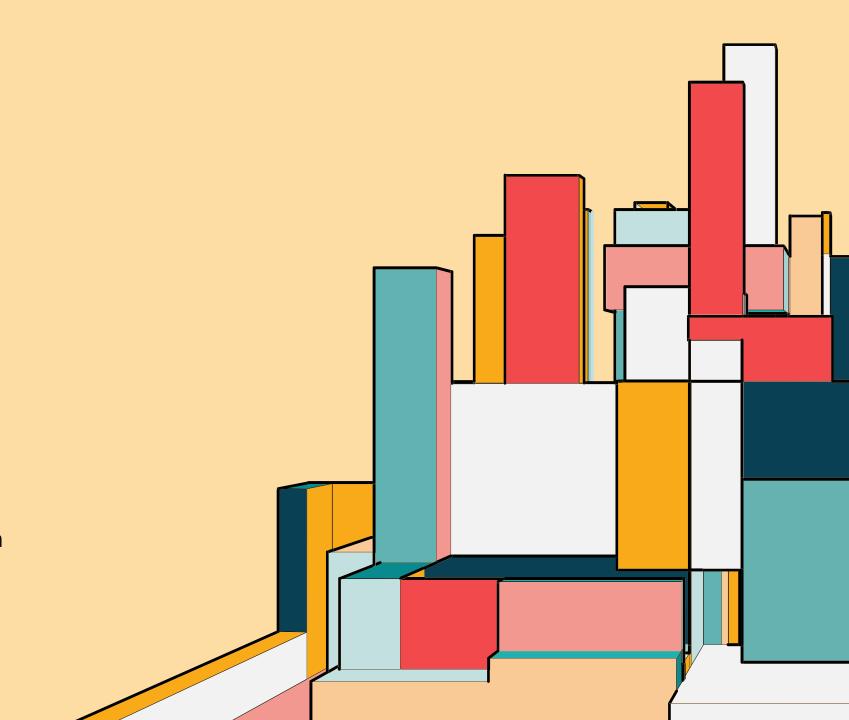



Schematic Plan Review

February 13, 2025





Case 24-092

Concept/Schematic Plan

Stager-Beckwith House (University Club)

Previous
Concept/Schematic
Review completed
December 12, 2024

Children's Museum of Cleveland 3813 Euclid Avenue

Addition


Project Representatives: Kaitlyn Boniecki, AODK, Inc.

Ward 7: Councilmember Howse-Jones







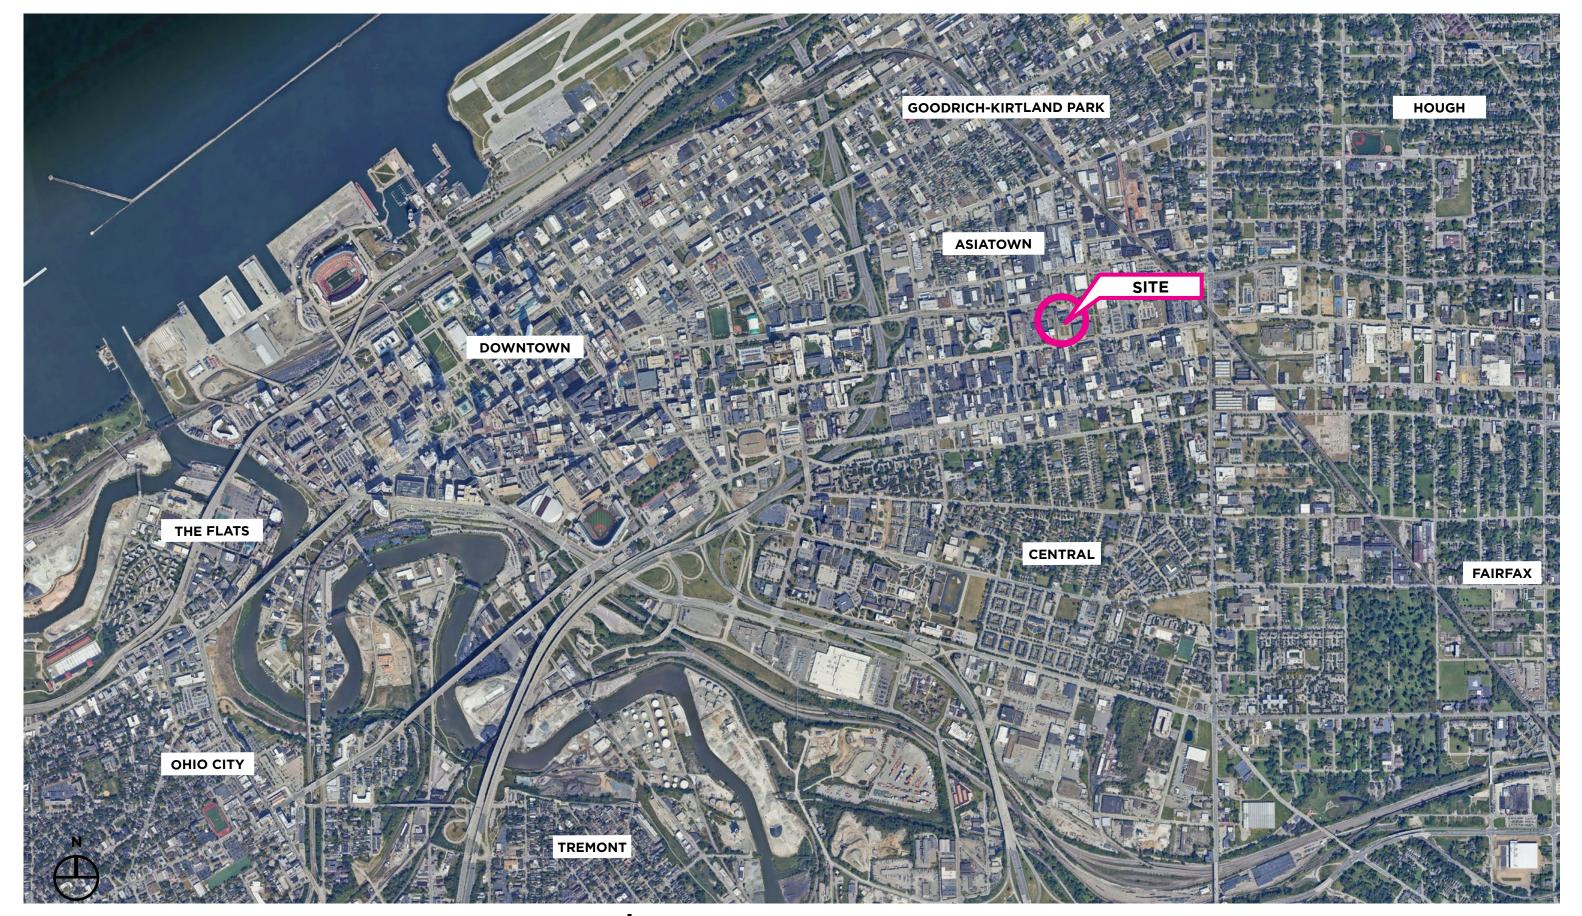































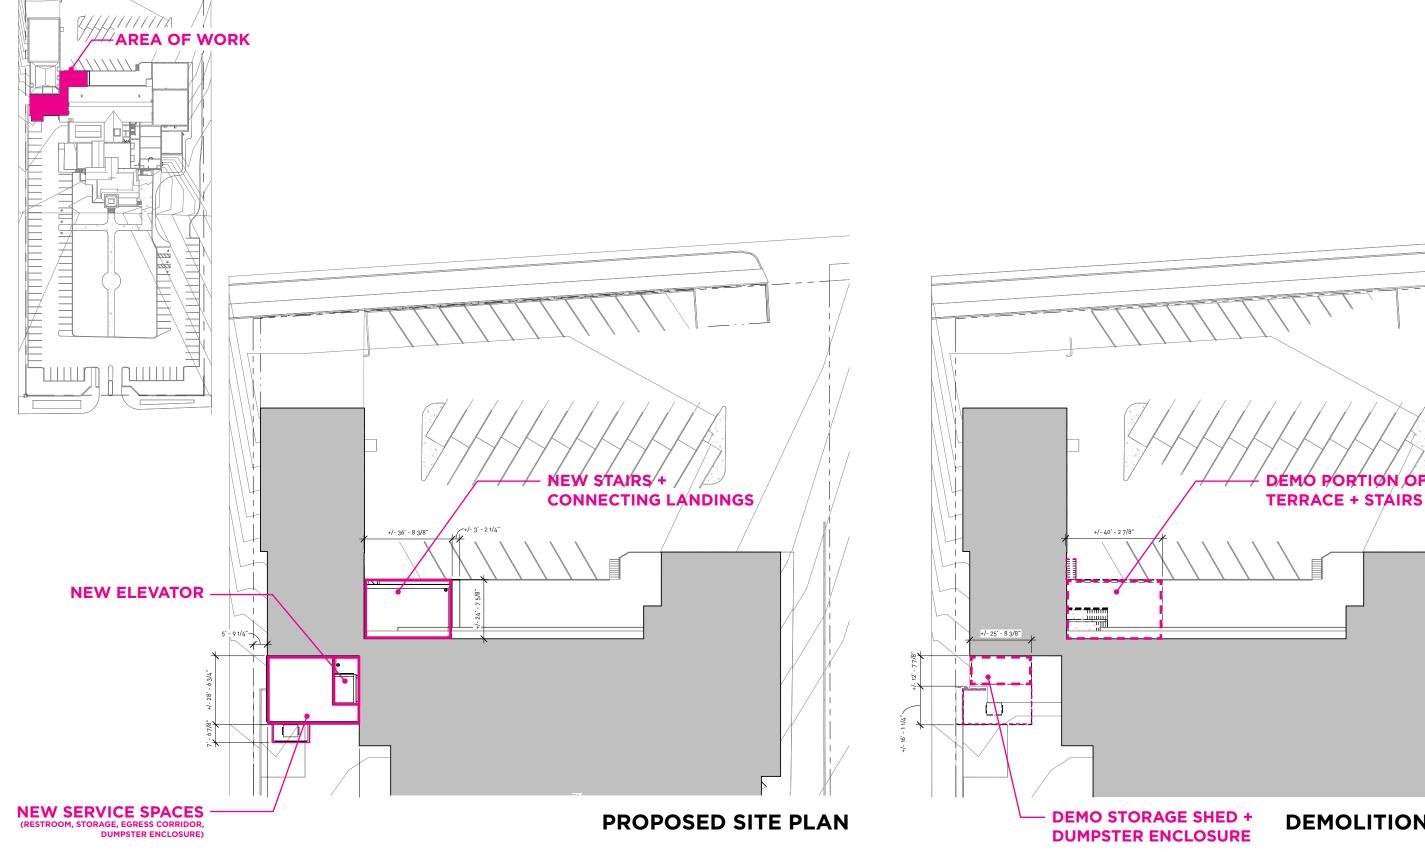



PROPOSED SITE PLAN | SERVICE ADDITION + REAR CONNECTOR

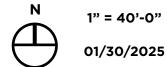


DEMOLITION SITE PLAN







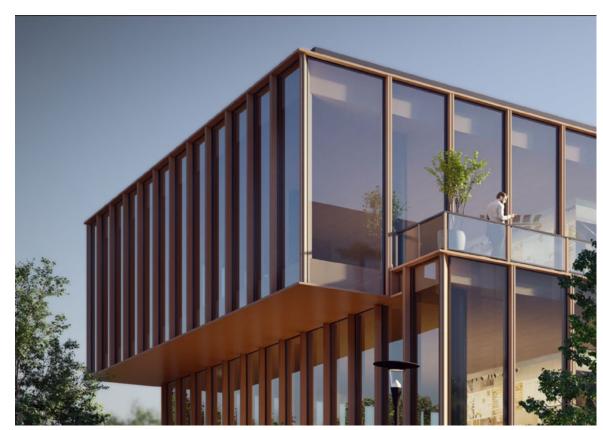










CMC | CONNECTOR ADDITION

PROPOSED PLANT LIST (LOWER LEVEL PLANTER)


BUXUS 'GREEN VELVET' / GREEN VELVET BOXWOOD

SIZE: #3 FOR INSTANT IMPACT, #1 FOR BUDGET **SPACING: 24" ON CENTER**

QUANTITY: 13

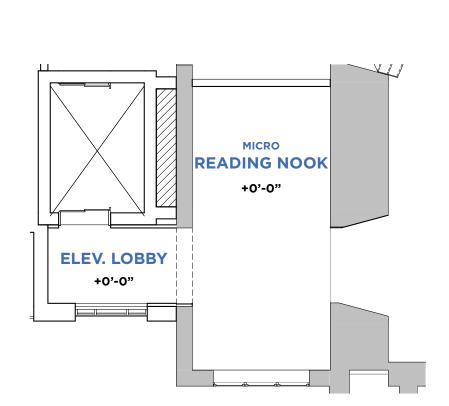


ADVENTURE CITY LOBBY

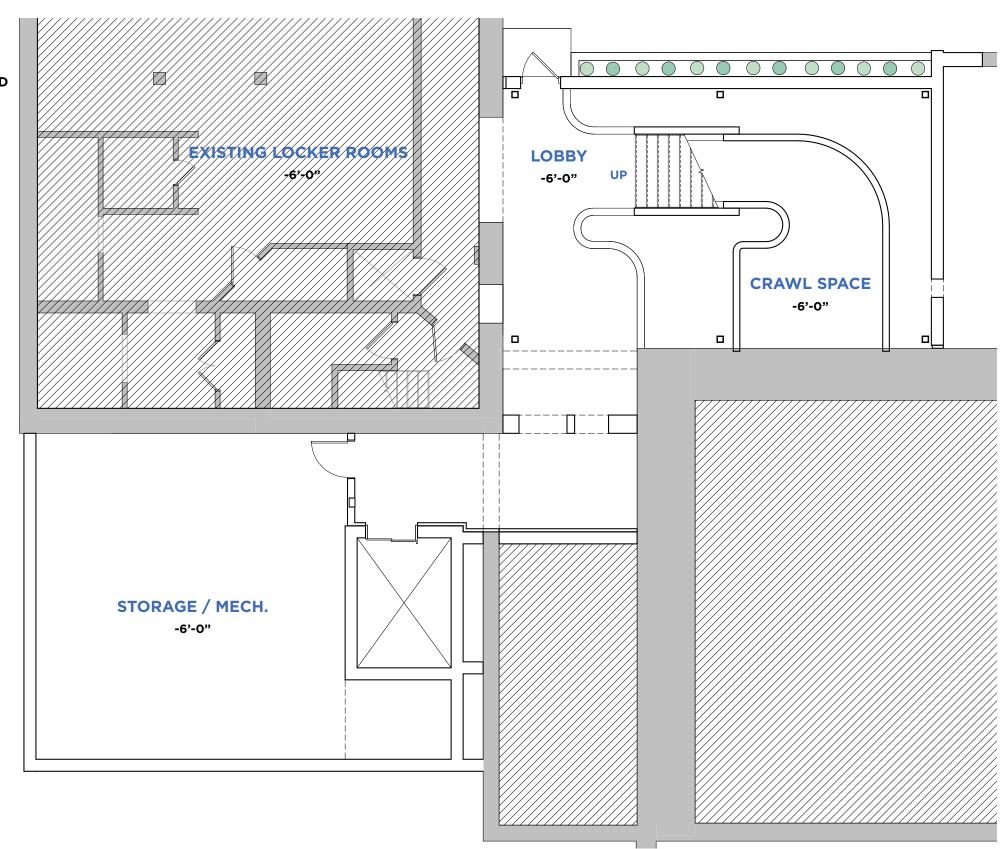


LOWER LEVEL PLAN

CMC | CONNECTOR ADDITION

LOWER LEVEL PLAN

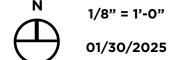

1/8" = 1'-0"

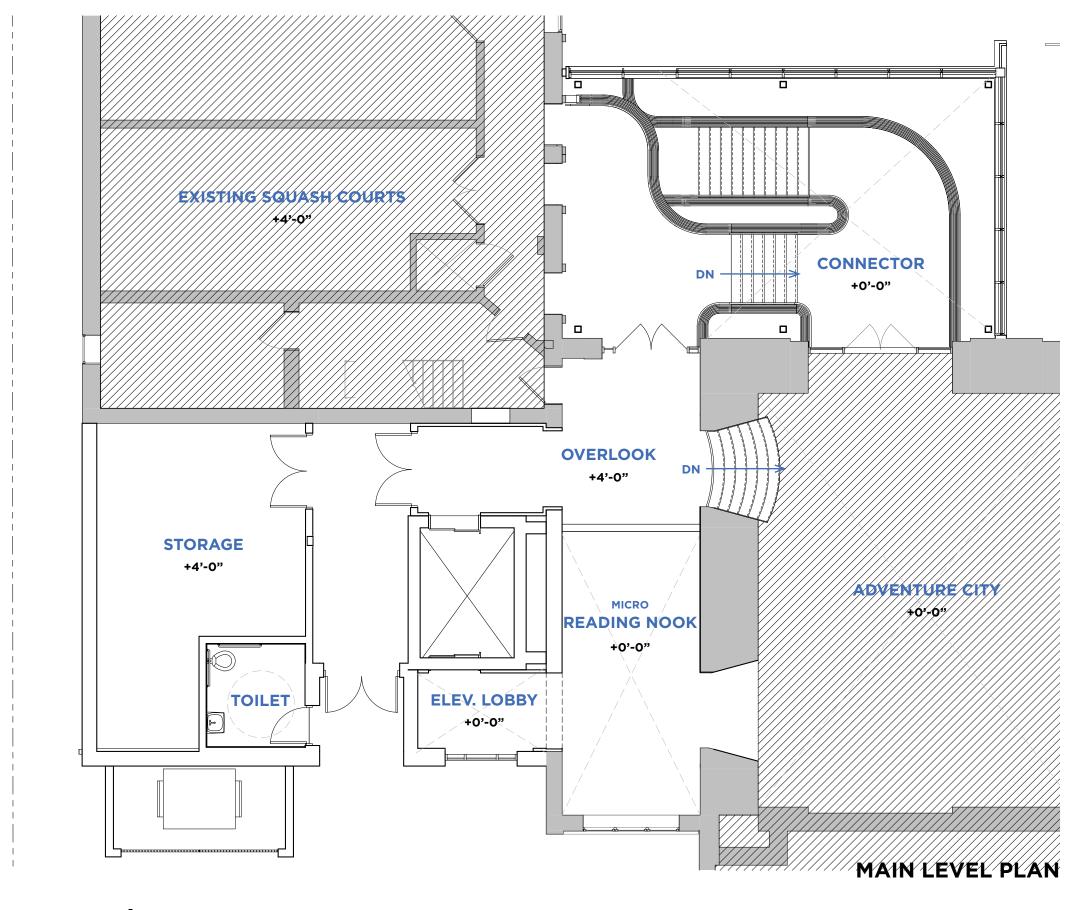





MAIN LEVEL PLAN



1/8" = 1'-0" 01/30/2025

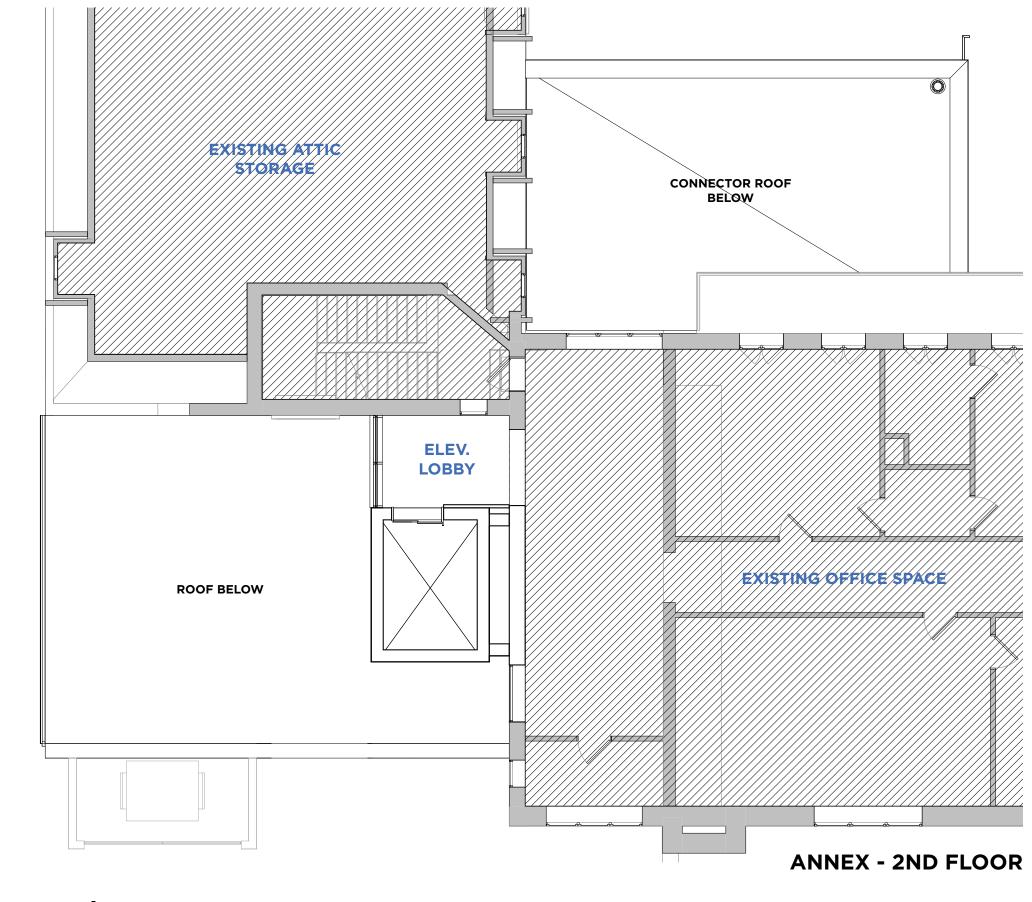

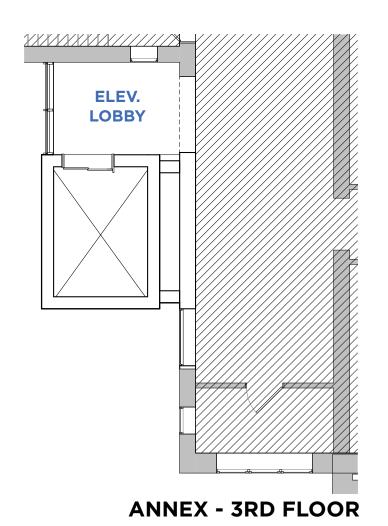




UPPER LEVEL PLAN(S)




1/8" = 1'-0" 01/30/2025





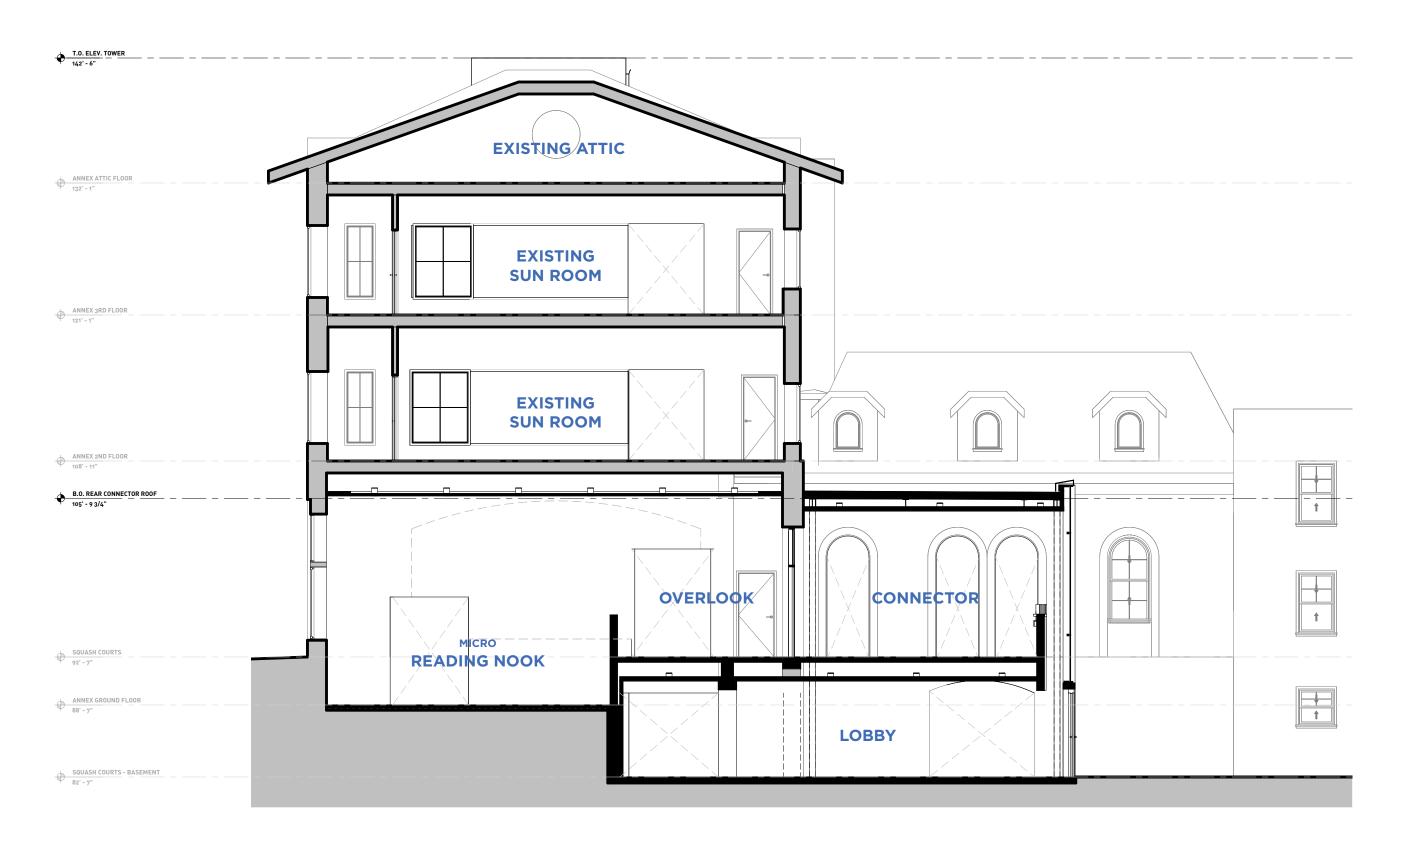



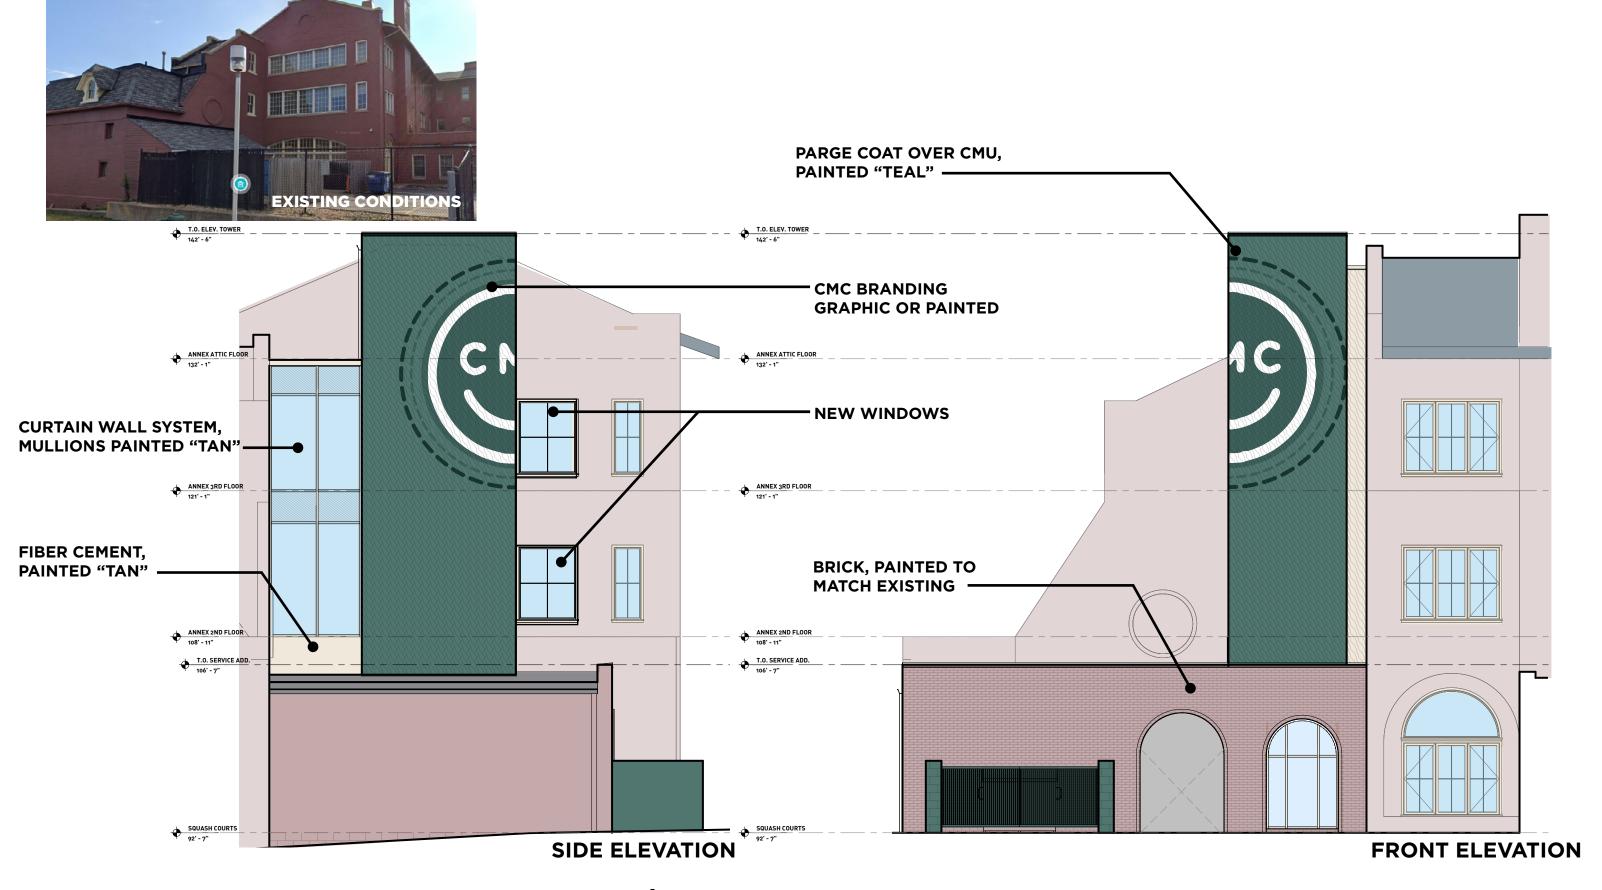










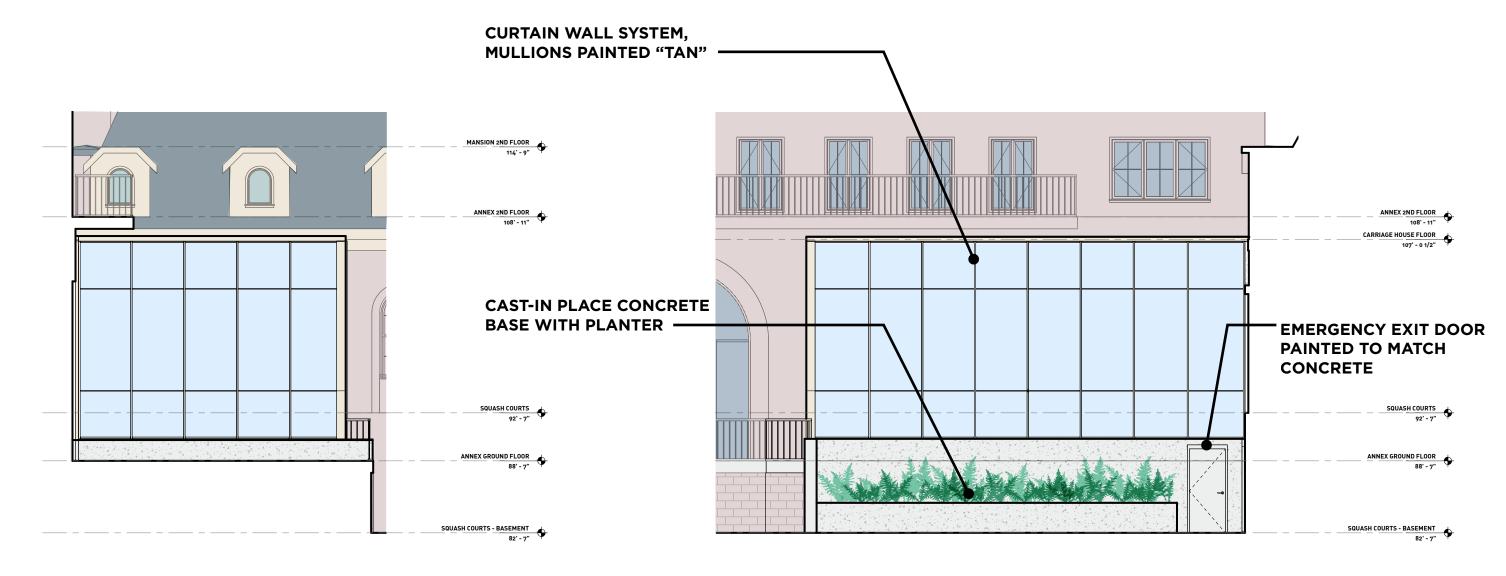



01/30/2025



